A PARCEL OF LAND LOCATED IN SECTION 16, TOWNSHIP 1 NORTH, RANGE 68 WEST OF THE SIXTH PRINCIPAL MERIDIAN, TOWN OF ERIE, COUNTY OF WELD, STATE OF COLORADO 390.8797 ACRES PD-001700-2024

PD ZONING LEGAL DESCRIPTION:

A PARCEL OF LAND LOCATED IN SECTION 16, TOWNSHIP 1 NORTH, RANGE 68 WEST OF THE SIXTH PRINCIPAL MERIDIAN, COUNTY OF WELD, STATE OF COLORADO MORE PARTICULARLY DESCRIBED AS FOLLOWS:

BASIS OF BEARINGS: BEARINGS ARE BASED ON THE ASSUMPTION THAT THE NORTH LINE OF THE SOUTHEAST 1/4 OF SECTION 16 BEING N 89°30′52″ E AND MONUMENTED AS FOLLOWS:

-CENTER 1/4 CORNER OF SECTION 16, BEING A FOUND 3.25" ALUMINUM CAP, LS 6973, RW BAYER ASSOC., PER MON REC DATED 3-1-14.

-EAST 1/4 CORNER OF SECTION 16, BEING A FOUND 2" ALUMINUM CAP IN RANGE BOX,

PARTIALLY ILLEGIBLE, PLS 14083, PER MONUMENT RECORD DATED 4-9-96.

BEGINNING AT THE CENTER 1/4 CORNER OF SECTION 16;

THENCE N 89°30′52″ E ALONG THE NORTH LINE OF THE SOUTHEAST 1/4 OF SAID SECTION 16 A DISTANCE OF 2630.74 FEET TO A POINT ON THE WESTERLY RIGHT-OF-WAY LINE OF WELD COUNTY ROAD NO. 7 AS DESCRIBED IN BOOK 86 PAGE 273;

THENCE S 00°22′39″ E ALONG SAID RIGHT-OF-WAY LINE A DISTANCE OF 2075.17 FEET TO THE NORTHEAST CORNER OF THAT SPECIAL WARRANTY DEED RECORDED AT RECEPTION NO. 4925429;

THENCE ALONG THE NORTHERLY BOUNDARY OF SAID SPECIAL WARRANTY DEED RECORDED AT RECEPTION NO. 4925429 THE **FOLLOWING FIVE (5) COURSES:**

1) S 89°37′21″W A DISTANCE OF 40.00 FEET; 2) S 00°22′39" E A DISTANCE OF 473.00 FEET; 3) ALONG A CURVE TO THE RIGHT HAVING A CHORD OF S 44°37′59″ W 35.36 FEET, A RADIUS OF 25.00 FEET, AN ARC OF 39.28 FEET, AND A DELTA OF 90°01′15″;

4) S 89°38′36″ W A DISTANCE OF 912.35 FEET; 5) S 00°21′24″ E A DISTANCE OF 40.00 FEET TO A POINT ON THE NORTHERLY RIGHT-OF-WAY LINE OF ERIE PARKWAY (AKA WELD COUNTY ROAD NO. 8) RECORDED IN BOOK 86 PAGE 273;

THENCE S 89°38′36" W ALONG SAID RIGHT-OF-WAY LINE A DISTANCE OF 1656.00 FEET;

THENCE S 89°38′17″W CONTINUING ALONG SAID RIGHT-OF-WAY LINE A DISTANCE OF 1343.47 FEET TO THE SOUTHEAST CORNER OF THAT PARCEL OF LAND RECORDED AT RECEPTION NO. 3158505;

THENCE N 00°13′30″ W ALONG THE EASTERLY BOUNDARY OF SAID PARCEL A DISTANCE OF 1949.87 FEET TO A POINT ON THE SOUTHERLY BOUNDARY OF THAT PARCEL OF LAND RECORDED AT RECEPTION NO. 4206840;

THENCE ALONG THE SOUTHERLY, EASTERLY AND NORTHERLY BOUNDARY OF SAID PARCEL OF LAND THE FOLLOWING SIX (6) COURSES:

1) N 89°38′27″ E A DISTANCE OF 2.00 FEET; 2) N 04°46′24" W A DISTANCE OF 110.00 FEET; 3) S 89°38′27″ W A DISTANCE OF 48.00 FEET; 4) N 44°31′51″ W A DISTANCE OF 339.83 FEET; 5) N 03°21′55″ E A DISTANCE OF 545.00 FEET; 6) S 89°31′06" W A DISTANCE OF 1032.00 FEET TO A POINT ON THE EASTERLY RIGHT-OF-WAY LINE OF WELD COUNTY ROAD NO. 5 RECORDED IN SAID BOOK 86 PAGE 273;

THENCE N 00°12′52″W ALONG SAID EASTERLY RIGHT-OF-WAY LINE A DISTANCE OF 2358.50 FEET TO A POINT ON THE SOUTHERLY RIGHT-OF-WAY LINE OF WELD COUNTY ROAD NO. 10 RECORDED IN SAID BOOK 86 PAGE 273;


THENCE N 89°23'44" E ALONG SAID SOUTHERLY RIGHT-OF-WAY LINE A DISTANCE OF 2624.71 FEET TO A POINT ON THE NORTH-SOUTH **CENTERLINE OF SAID SECTION 16**;

THENCE S 00°18'49" E ALONG SAID NORTH-SOUTH CENTERLINE OF SAID **SECTION 16 A**

DISTANCE OF 2607.31 FEET TO THE POINT OF BEGINNING.

THE ABOVE DESCRIBED PARCEL CONTAINS 17.026,720 SOUARE FEET OR 390.8797 ACRES MORE OR LESS.

COVER SHEET / GENERAL NOTES

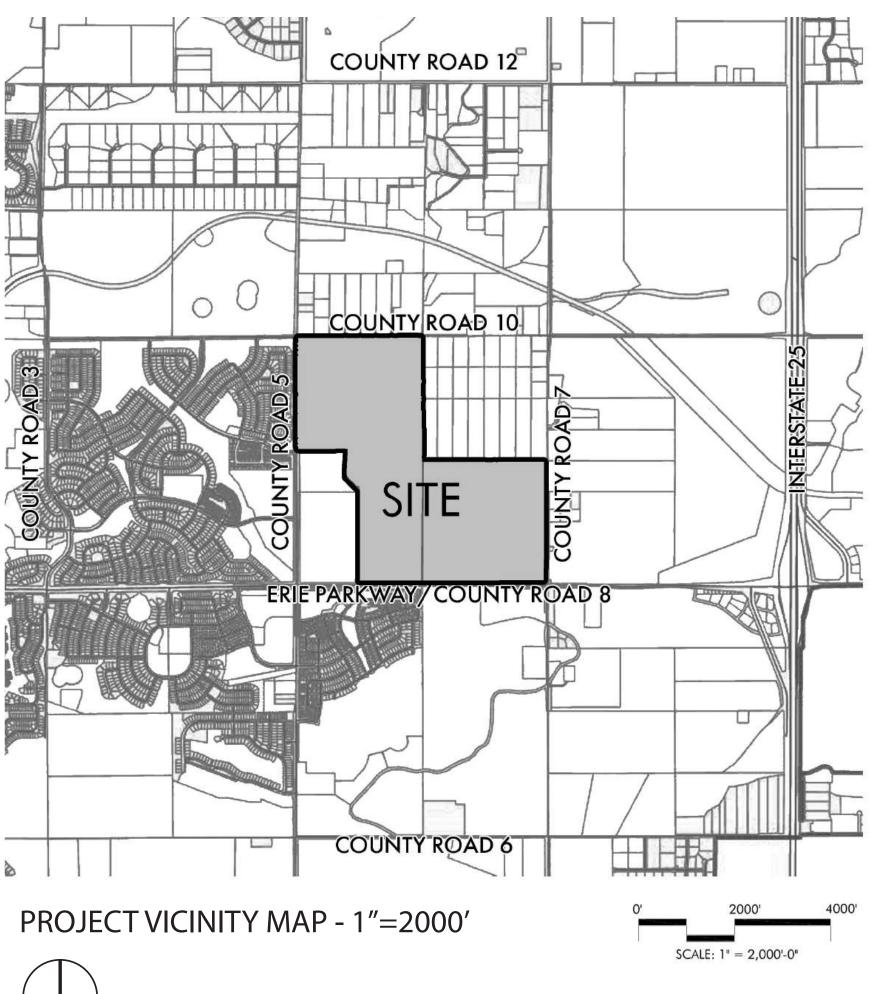

GENERAL NOTES:

- SOME ITEMS CONTAINED WITHIN THE PD WILL BE CONCEPTUAL IN NATURE AND ARE SUBJECT TO CHANGE THROUGH PRELIMINARY PLAT AND FINAL PLAT STAGES.
- THE GRAPHIC DRAWINGS CONTAINED WITHIN THIS PD ARE INTENDED TO DEPICT GENERAL LOCATIONS AND ILLUSTRATE CONCEPTS OF THE TEXTUAL PROVISIONS. DURING THE PLATTING PROCESS MINOR VARIATIONS SHOULD BE EXPECTED FOR THE PURPOSE OF ESTABLISHING:
 - 1. FINAL ROAD ALIGNMENTS
 - 2. FINAL CONFIGURATION OF LOT AND TRACT SIZES AND SHAPES
 - 3. FINAL BUILDING ENVELOPES
 - 4. FINAL ACCESS AND PARKING LOCATIONS
 - 5. LANDSCAPE ADJUSTMENTS
- ALL THE PHOTOS AND ILLUSTRATIONS REFERENCED IN THIS PD ARE REPRESENTATIVE OF THE LEVEL OF DESIGN QUALITY IN NORTH WESTERLY. FINAL DESIGNS TO BE SUBMITTED WILL NOT NECESSARILY DUPLICATE THE EXACT ILLUSTRATIONS, BUT WILL CONTAIN THE SAME THEMES AND DIMENSIONS AS SHOWN, AND WILL BE AT THE SAME OR HIGHER LEVEL OF DESIGN QUALITY, EXTENT, AND DETAIL.

VESTED RIGHTS:

THIS PD CONSTITUTES A SITE SPECIFIC DEVELOPMENT PLAN AS DEFINED IN C.R.S. § 24-68-101, ET SEQ., AND CHAPTER 3 OF TITLE 9 OF THE ERIE MUNICIPAL CODE AND SHALL CREATE VESTED PROPERTY RIGHTS FOR 7 YEARS FROM THE DATE OF APPROVAL OF THE PD-DP, PROVIDED THAT ALL REQUIRED PROCEDURES ARE FOLLOWED. IF BUILDING PERMITS FOR AT LEAST 50% OF THE UNITS CONTEMPLATED BY THIS PD HAVE BEEN ISSUED WITHIN 7 YEARS OF THE DATE OF TOWN'S FINAL APPROVAL OF THIS PD, THE VESTING TERM SHALL BE AUTOMATICALLY EXTENDED FOR AN ADDITIONAL 3 YEARS.

NORTH WESTERLY OWNER, LLC 3990 HILLSBORO PIKE, SUITE 400,

NASHVILLE, TN 37215 720-531-8924 CONTACT: JIM HENRY

JIM.HENRY@SOUTHERNLAND.COM

PLANNING CONSULTANTS: SOUTHERN LAND COMPANY 3990 HILLSBORO PIKE, SUITE 400, NASHVILLE, TN 37215 615.778.2884

CONTACT: BEN CRENSHAW SHANE WHITE

BEN.CRENSHAW@SOUTHERNLAND.COM SHANE.WHITE@SOUTHERNLAND.COM

PCS GROUP, INC. 200 KALAMATH STREET DENVER, COLORADO 80223 720.259.8246 CONTACT: JOHN PRESTWICH CARLI GARCIA-RODRIQUEZ

JOHN@PCSGROUPCO.COM CARLI@PCSGROUPCO.COM

ENGINEERING CONSULTANTS:

KT ENGINEERING 12500 W. 58TH AVE, SUITE 230 720-638-5190

CONTACT: KENTOLAND KTOLAND@KTENG.NET

TRAFFIC CONSULTANTS:

LSC TRANSPORTATION CONSULTANTS, INC. 1889 YORK STREET

DENVER, CO 80206 303.333.1105

CONTACT: CHRISTOPHER MCGRANAHAN CSMCGRANAHAN@LSCTRANS.COM

SHEET INDEX

SHEET 1: COVER SHEET

SHEET 2: ZONING MAP

SHEET 3: CONCEPT PLAN

SHEET 4: HOME DIVERSITY PLAN

SHEET 5: SINGLE FAMILY DETACHED DEVELOPMENT

STANDARDS

SHEET 6: SINGLE FAMILY ATTACHED DEVELOPMENT

STANDARDS

SHEET 7: MULTI-FAMILY DEVELOPMENT STANDARDS

SHEET 8-9: COMMERCIAL DEVELOPMENT STANDARDS

SHEET 10: DEVELOPMENT STANDARDS

SHEET 11: UTILITY CONCEPT PLAN

SHEET 12: OIL & GAS PLAN

SHEET 13: UNDERMINING PLAN

SHEET 14: STREETSCAPE PLAN

SHEET 15: PEDESTRIAN CIRCULATION PLAN

SHEET 16: BICYCLE CONNECTIVITY PLAN

SHEET 17: SIGNAGE PLAN

SHEET 18: OVERALL LIGHTING PLAN

SHEET 19: PARKS & OPEN SPACE CONCEPT

SHEET 20: PARKS & OPEN SPACE CONCEPT PLAN

SHEET 21: PHASING PLAN

SHEET 22: ENVIRONMENTAL PLAN

DO HEREBY CERTIFY THAT THIS ZONING MAP TRULY AND CORRECTLY REPRESENTS THE ABOVE DESCRIBED LEGAL

I ATTEST THE ABOVE ON THIS ___ DAY OF _____, 20___.

SIGNATURE

TOWN COUNCIL APPROVAL CERTIFICATE:

THIS ZONING MAP IS TO BE KNOWN AS THE ZONING MAP" AND IS APPROVED AND ACCEPTED BY ORDINANCE NO. , PASSED

MAYOR			

TOWN CLERK

STATE OF)
) (

BY:
(SIGNATURE)

(COUNTY CLERK AND RECORDER)

SURVEYOR'S CERTIFICATE: _, A DULY REGISTERED PROFESSIONAL LAND SURVEYOR IN THE STATE OF COLORADO, DESCRIPTIONS FOR EACH ZONE DISTRICT. SURVEYOR'S NAME COLORADO REGISTERED PROFESSIONAL LAND SURVEYOR (SEAL)

AND ADOPTED AT A MEETING OF THE TOWN COUNCIL FOR ERIE, COLORADO, HELD ON

MAYOR			
ATTECT			

CLERK AND RECORDER'S CERTIFICATE:


) SS
COUNTY OF)
I HEREBY CERTIFY THAT HIS ZONING MAP WAS FILED
IN MY OFFICE ON THIS DAY OF
20 A.D AND WAS RECORDED AT THE RECEPTION
NUMBER
BY:
(616)1471197


PREPARED FOR: NORTH WESTERLY OWNER, LLC 3990 HILLSBORO PIKE SUITE 400, NASHVILLE, TN 37215 720-531-8924 CONTACT: JIM HENRY **ENGINEERING:** SUITE 230 ARVADA, CO 80002 720-638-5190 CONTACT: KEN TOLAND LAND PLANNING: Southern Land COMPANY 3990 HILLSBORO PIKE, SUITE 400, NASHVILLE, TN 37215 615.778.2884 CONTACT: **BEN CRENSHAW** PCS GROUP, INC. 200 KALAMATH STREET DENVER, CO - 80233 720-259-8246 CONTACT: JOHN PRESTWICH **REVISIONS:** SHEET INFO:

E A \overline{S} Z E E

DRAWN BY: CGR **DESIGNED BY:** BC/SW

SUBMITTED ON: 2/09/2023

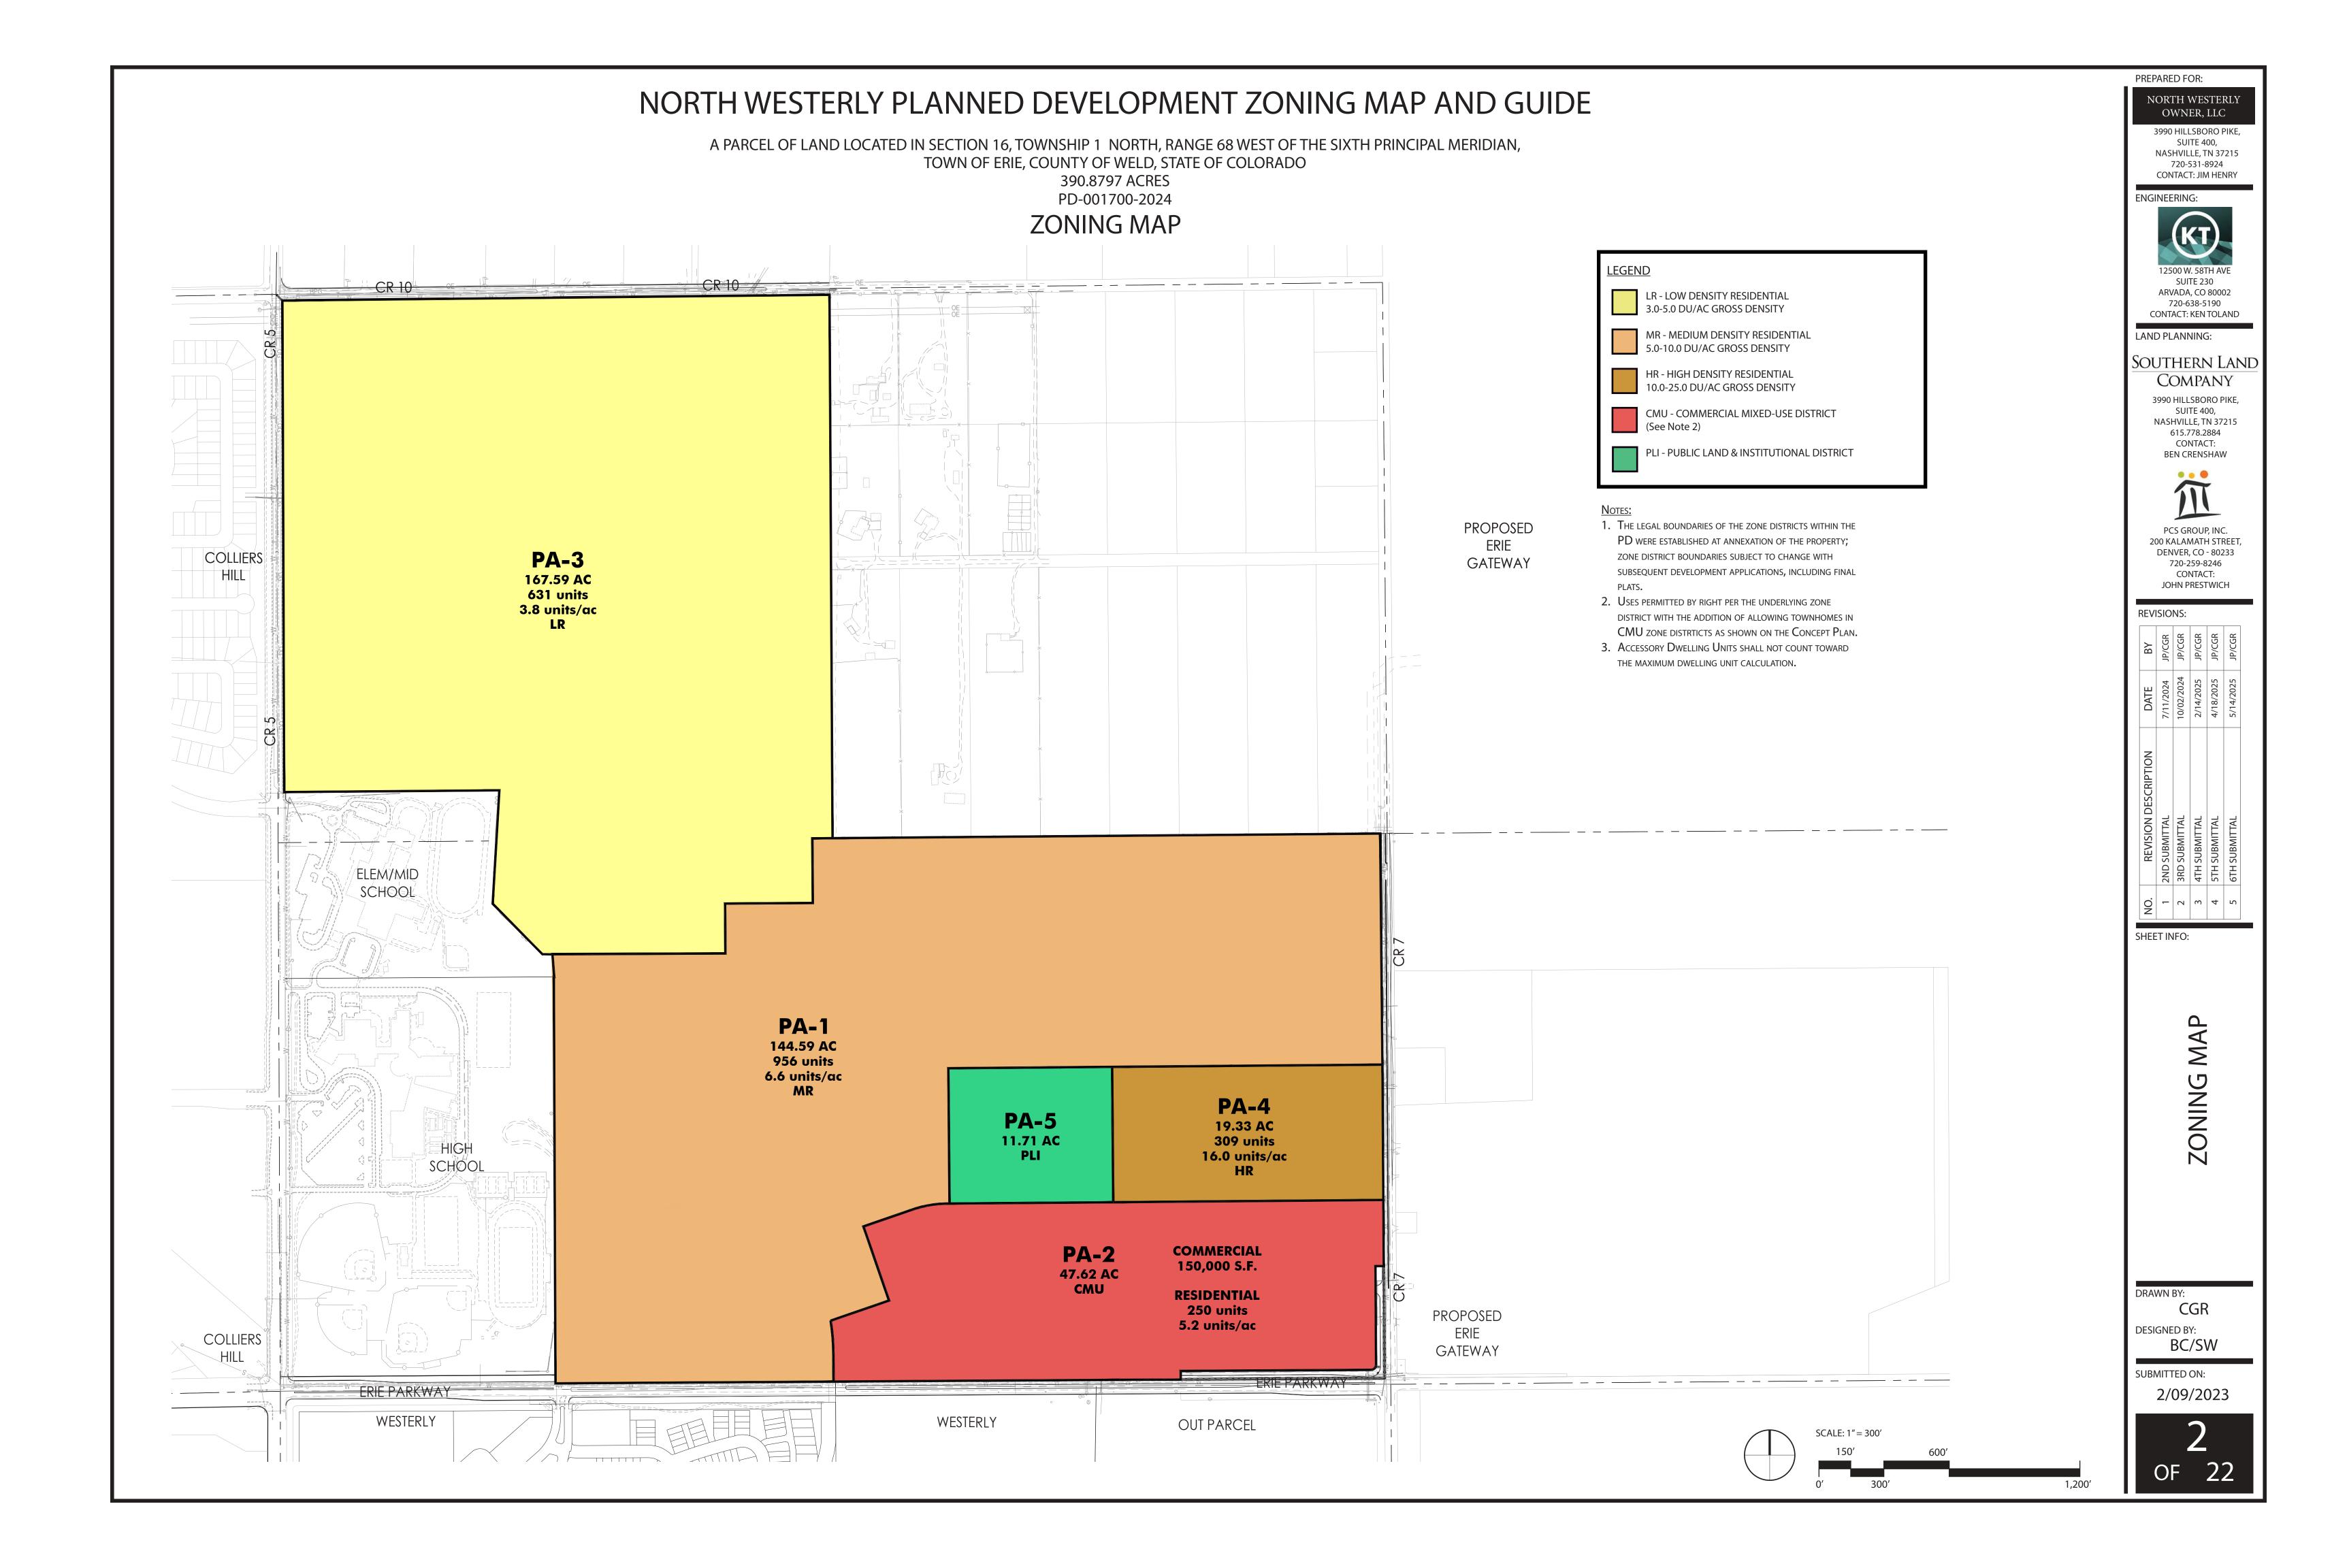

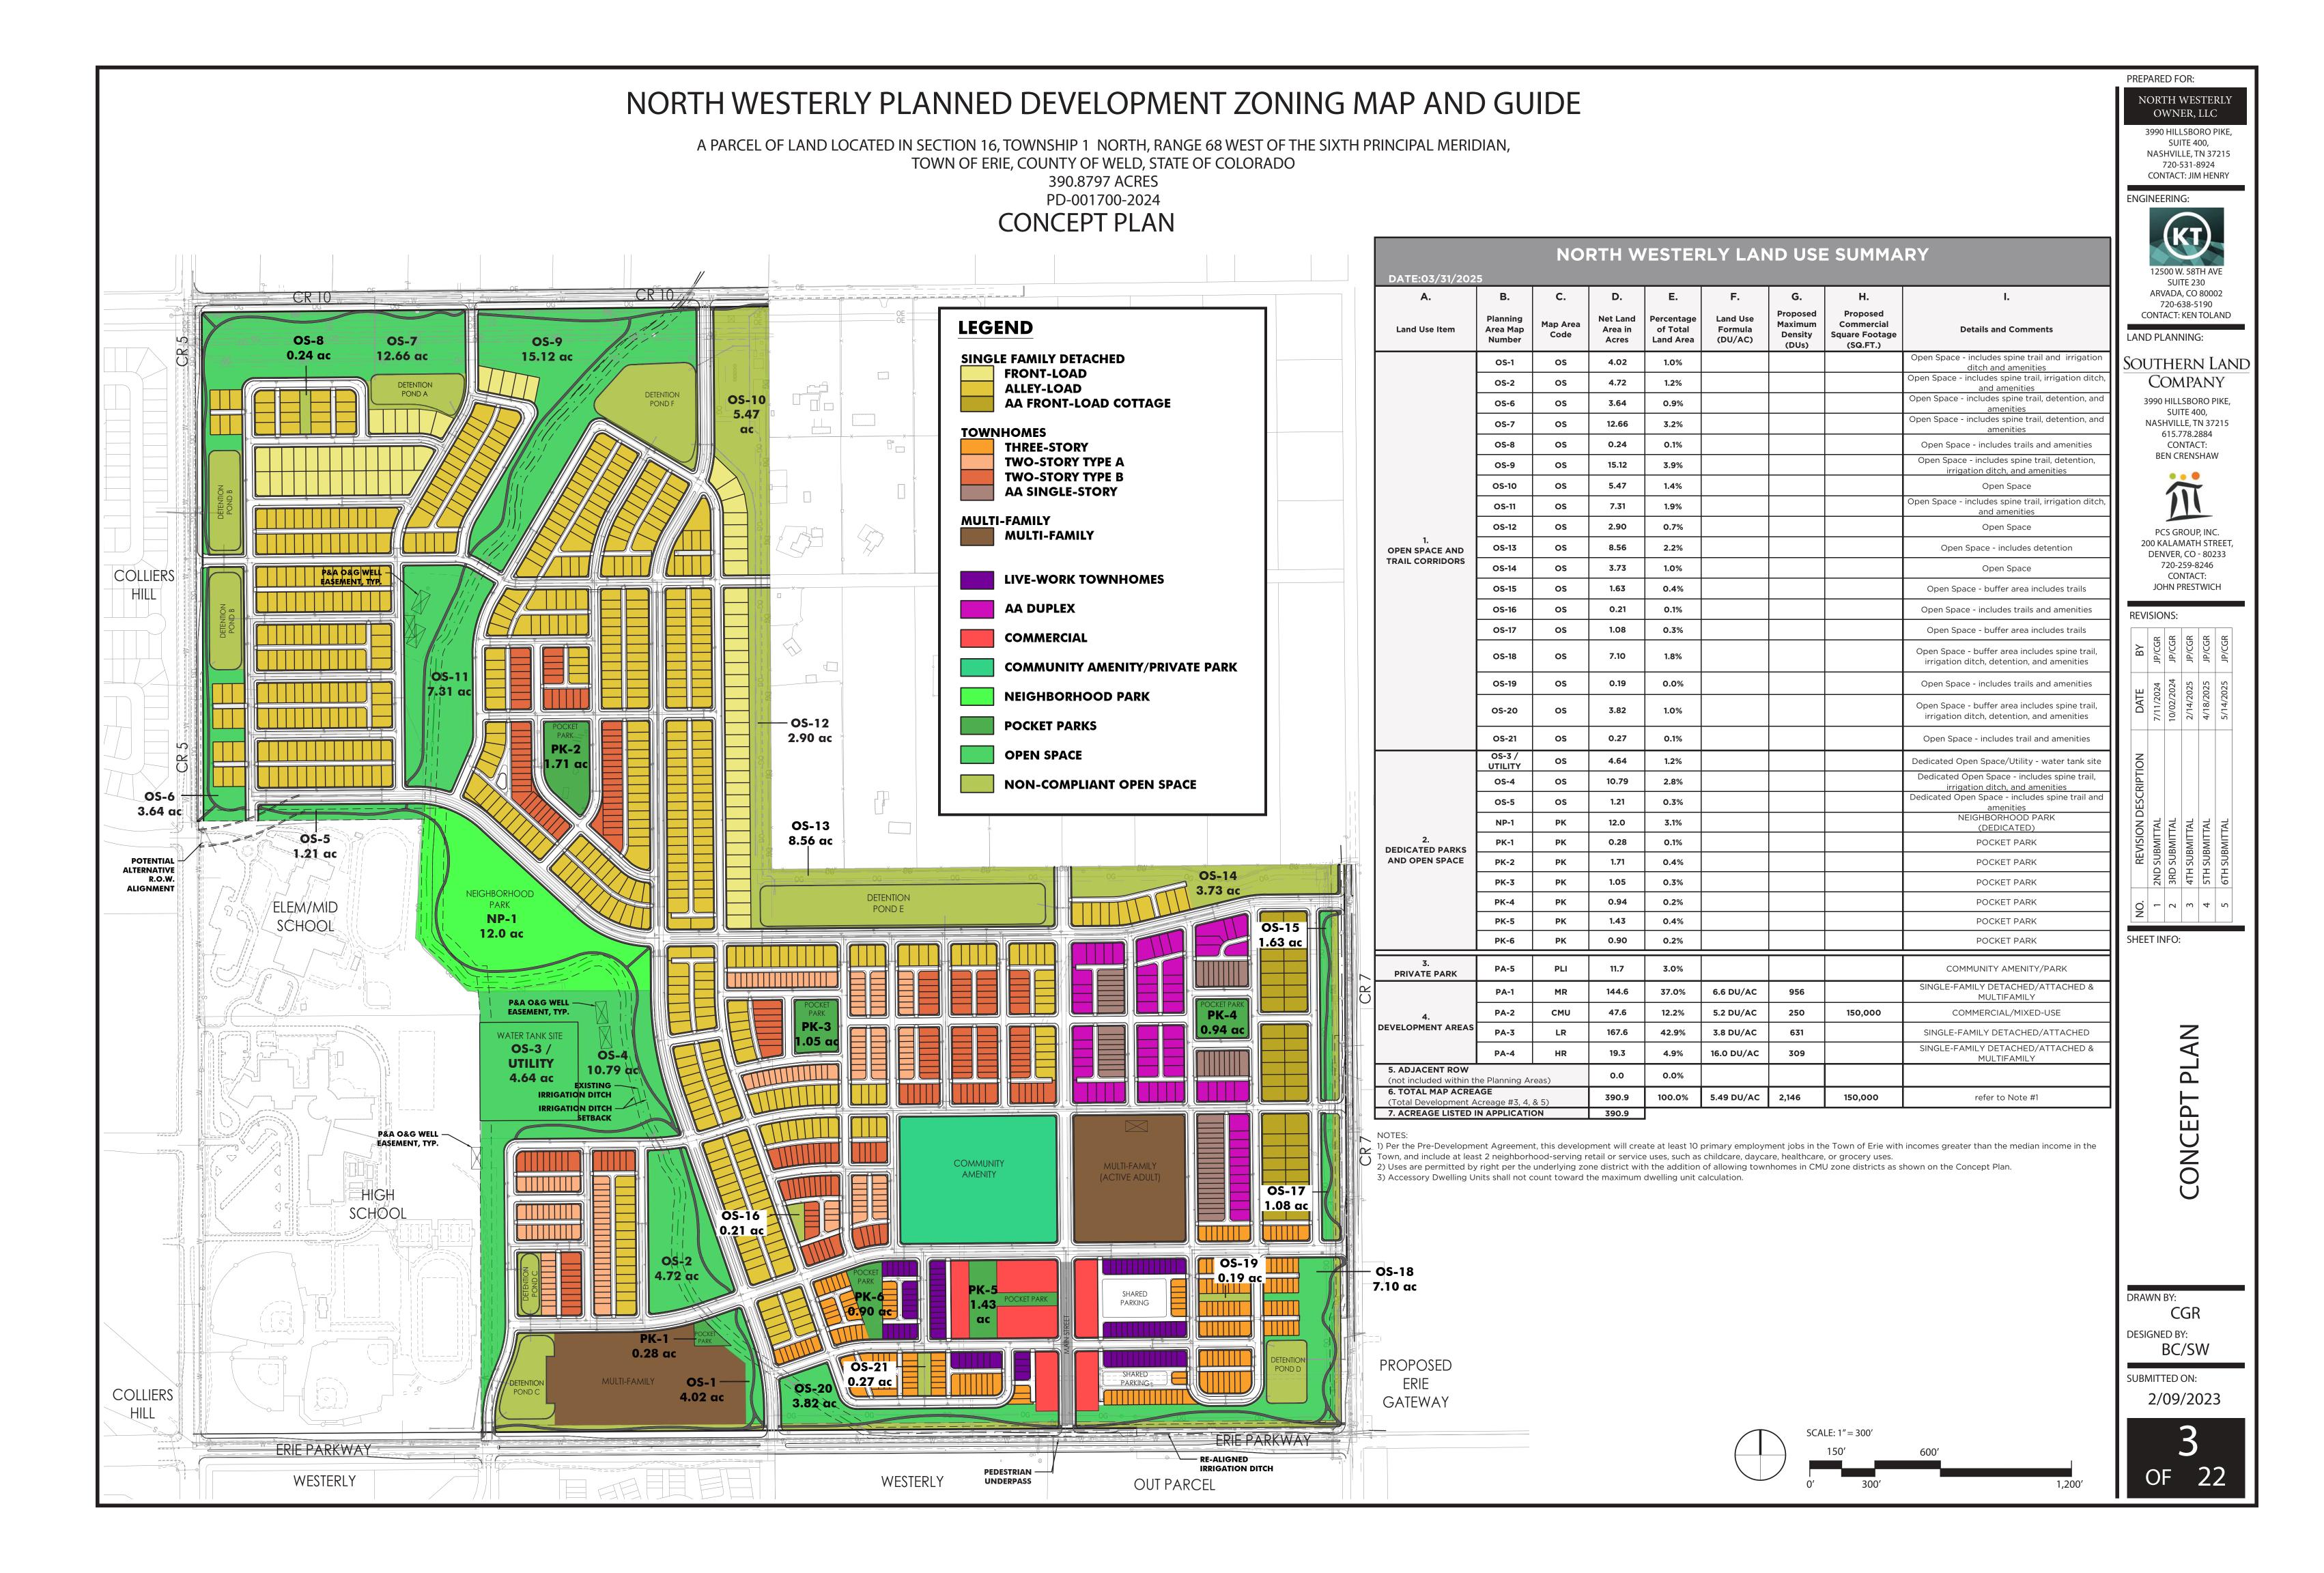

A PARCEL OF LAND LOCATED IN SECTION 16, TOWNSHIP 1 NORTH, RANGE 68 WEST OF THE SIXTH PRINCIPAL MERIDIAN, TOWN OF ERIE, COUNTY OF WELD, STATE OF COLORADO 390.8797 ACRES PD-001700-2024

HOME DIVERSITY PLAN

TABLE 6.7-1:	HOUSING DIV	ERSITY (TOWN OF ERI	E)	
DEVELOPMENT PARCEL SIZE	REQUIRED MIX OF	HOUSING T	YPES FOR NORTH V	WESTERLY	
321-480 ACRES (NORTH WESTERLY IS IN THIS RANGE)	5 HOUSING TYPES	OR	4 HOUSING TYPES AND 1 HOUSING TYPE VARIATION	OR	3 HOUSING TYPES AND 2 HOUSING TYPE VARIATIONS

		INCLUDED IN NORTH WESTERLY
(A)	DUPLEX	YES
(B)	STACKED TRI-PLEX / QUAD-PLEX	NO
(C)	MANOR HOME	NO
(D)	TOWNHOUSE (SINGLE-FAMILY ATTACHED DWELLING UNIT)	YES
(E)	APARTMENT (MULTI-FAMILY DWELLING UNIT)	YES
(F)	LIVE-WORK UNITS	YES
(G)	SINGLE-FAMILY DETACHED	YES
HOUSING	TYPE VARIATIONS THAT APPLY TO TABLE 6.7	7-7 INCLUDE:
(A)	DUPLEX	INCLUDED
	a. FRONT LOAD	NO
	b. ALLEY LOAD	YES
(B)	STACKED TRI-PLEX / QUAD-PLEX	NA
	a. THREE DWELLING UNITS PER BUILDING	
	b. FOUR DWELLING UNITS PER BUILDING	
(C)	MANOR HOME	NA
	a. VARIATION IN BUIDLING LENGTH OF 30% OR MORE	
	b. VARIATION IN BUIDLING FOOTPRINT OF 30% OR MORE	
(D)	TOWNHOUSE (SINGLE-FAMILY ATTACHED DWELLING UNIT)	INCLUDED
	a. FRONT LOAD	NO
	b. ALLEY LOAD	YES
(E)	APARTMENT (MULTI-FAMILY DWELLING UNIT)	INCLUDED
	a. VARIATION IN BUIDLING LENGTH OF 30% OR MORE	NO
	b. VARIATION IN BUIDLING FOOTPRINT OF 30% OR MORE	NO
(F)	LIVE-WORK UNITS	INCLUDED
	a. FRONT LOAD	NO
	b. ALLEY LOAD	YES
(G)	SINGLE-FAMILY DETACHED	INCLUDED
	a. FRONT LOAD	YES
	b. ALLEY LOAD	YES
	c. LOT SIZE UNDER 5,000 SQUARE FEET	YES
	d. LOT SIZE 5,000 TO 9,999 SQUARE FEET	YES
	e. LOT SIZE 10,000 TO 39,999 SQUARE FEET	NO
	f. LOT SIZE 40,000 SQUARE FEET OR MORE	NO

UNIT TYPE	LOT WIDTH (FT)	LOT DEPTH (FT)	LOT COUNT	SEGMENT MIX (%)	DEVELOPMENT MIX (%
SINGLE FAMILY DETACHED UNITS					
SINGLE-FAMILY FRONT LOAD	55′	105′	77	9.4%	3.6%
SINGLE-FAMILY ALLEY LOAD	35' OR 45'	90′	691	84.5%	32.2%
AA-COTTAGE	55′	105′	50	6.1%	2.3%
SUBTOTAL			818	100.0%	38.1%
ATTACHED UNITS					
LIVE-WORK TOWNHOME	25′	50′	95	11.3%	4.4%
TOWNHOUSE - THREE STORY	25′	67'	206	24.5%	9.6%
TOWNHOUSE - TWO STORY (TYPE A)	26′	67′	178	21.2%	8.3%
TOWNHOUSE - TWO STORY (TYPE B)	26′	90′	221	26.3%	10.3%
AA TOWNHOME	23'	120′	61	7.3%	2.8%
AA DUPLEX	40′	90′	80	9.5%	3.7%
SUBTOTAL			841	100.0%	39.2%
SINGLE FAMILY ATTACHED & DETACHED SUBTO	DTAL		1,659		77.3%
FAMILY RESIDENTIAL (SEE NOTE)				•	
UNIT TYPE	FLOORPLATE (GSF)	BUILDING STORIES	LOT COUNT	SEGMENT MIX (%)	DEVELOPMENT MIX (
MULTI-FAMILY	132,780	2.5	250	51.3%	11.6%
AA MULTI-FAMILY	101,304	3	237	48.7%	11.0%
MULTI-FAMILY SUBTOTAL			487	100.00%	22.7%

1) HIGHER DENSITY HOUSING: DEVELOPER SHALL CAUSE AT LEAST 20% OF THE TOTAL RESIDENTIAL UNITS IN THE DEVELOPMENT TO BE CONSTRUCTED AS HIGHER DENSITY HOUSING, INCLUDING WIHTOUT LIMITATION CONDOMINIUMS, TOWNHOMES, APARTMENTS, AND COOPERATIVE HOUSING.

2) ACCESSORY DWELLING UNITS WILL BE ALLOWED FOR SINGLE FAMILY DETACHED HOMES, HOWEVER, THEY HAVE NOT BEEN CAPTURED IN THE UNIT COUNTS OR PERCENTAGES. 3) LOT WIDTHS AND DEPTHS ARE TO SHOW HOUSING DIVERSITY. INFORMATION LISTED ON THIS PAGE ARE NOT REQUIRED DIMENSIONAL STANDARDS.









TOTAL GROSS SF DEVELOPMENT MIX (%)

77.31%

22.69%

100.00%

(D) - TOWNHOUSE - ALLEY LOAD

LOT COUNT

1,659

487


2,146

PREPARED FOR:

OWNER, LLC 3990 HILLSBORO PIKE, SUITE 400, NASHVILLE, TN 37215 720-531-8924 CONTACT: JIM HENRY

NORTH WESTERLY

ENGINEERING:

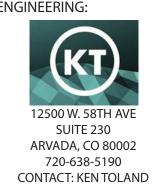

LAND PLANNING:

Southern Land COMPANY

3990 HILLSBORO PIKE, SUITE 400, NASHVILLE, TN 37215 615.778.2884 CONTACT: BEN CRENSHAW



CONTACT: JOHN PRESTWICH

REVI	SIO	NS:				
ВУ	JP/CGR	JP/CGR	JP/CGR	JP/CGR	JP/CGR	
DATE	7/11/2024	10/02/2024	2/14/2025	4/18/2025	5/14/2025	
REVISION DESCRIPTION	2ND SUBMITTAL	3RD SUBMITTAL	4TH SUBMITTAL	5TH SUBMITTAL	6TH SUBMITTAL	
NO.	_	2	3	4	5	

SHEET INFO:

E DIVERSITY PLAN HOME

DRAWN BY: CGR **DESIGNED BY:** BC/SW

SUBMITTED ON: 2/09/2023

(G) - SINGLE FAMILY DETACHED - FRONT LOAD

(G) - SINGLE FAMILY DETACHED - ALLEY LOAD

(A) - DUPLEX - ALLEY LOAD

TOTAL SINGLE FAMILY ATTACHED & DETACHED UNITS

TOTAL MULTI-FAMILY UNITS

OVERALL DEVELOPMENT TOTALS

A PARCEL OF LAND LOCATED IN SECTION 16, TOWNSHIP 1 NORTH, RANGE 68 WEST OF THE SIXTH PRINCIPAL MERIDIAN, TOWN OF ERIE, COUNTY OF WELD, STATE OF COLORADO

390.8797 ACRES PD-001700-2024

SINGLE FAMILY DETACHED DEVELOPMENT STANDARDS

E. AN ELEVATION OF THE HOME THAT FACES A STREET, PARK, TRAIL

THE SINGLE FAMILY DETACHED ARCHITECTURAL STANDARDS SHALL APPLY TO ALL SINGLE FAMILY TYPES INCLUDING FRONT LOAD, ALLEY LOAD, LOT SIZE UNDER 5,000 SQUARE FEET, LOT SIZE 5,000 TO 9,999 SQUARE FEET. THE SINGLE FAMILY DETACHED ARCHITECTURAL STANDARDS REPLACE SECTIONS 10.6.7 OF THE ERIE UNIFIED DEVELOPMENT CODE, AS THE

SINGLE FAMILY DETACHED ARCHITECTURAL STANDARDS

I. ARCHITECTURAL VARIETY

SAME MAY BE AMENDED FROM TIME TO TIME.

A. VARIETY

- 1. NO IDENTICAL MODEL PLAN ELEVATION SHALL BE REPEATED DIRECTLY ACROSS ANY STREET FROM THE SAME MODEL PLAN AND ELEVATION.
- 2. NO IDENTICAL MODEL PLAN ELEVATION SHALL BE REPEATED MORE THAN ONCE WITHIN EVERY 4 LOTS ON THE SAME SIDE OF ANY STREET.
- 3. A MINIMUM OF 3 RECOGNIZABLY DIFFERENT MODEL PLANS WITH 3 RECOGNIZABLY DIFFERENT ELEVATIONS BE SUBMITTED TO THE TOWN FOR REVIEW.

B. TRACKING

1. IT SHALL BE THE RESPONSIBILITY OF THE DEVELOPER TO PROVIDE TO THE TOWN A PLAT SHEET TRACKING DOCUMENT THAT MAINTAINS A RECORD OF HOME MODEL VARIETY FOR EVERY DEVELOPMENT PARCEL. THE DEVELOPER SHALL DEMONSTRATE COMPLIANCE WITH THIS SECTION PRIOR TO ISSUANCE OF A BUILDING PERMIT.

II. ARCHITECTURAL CHARACTER

EACH SINGLE FAMILY DETACHED MODEL PLAN AND ELEVATION SHALL DEMONSTRATE THE FOLLOWING DESIGN ATTRIBUTES:

A. EACH ELEVATION SHALL INCLUDE A MINIMUM OF TWO WINDOWS (OR ONE WINDOW AND ONE DOOR) PER FLOOR. THERE SHALL BE AT LEAST ONE OPENING (WINDOW OR DOOR) PER OUADRANT OF THE ELEVATION SO THAT LONG STRETCHES OF WALL ARE BROKEN UP BY FENESTRATION. HOWEVER, ELEVATIONS WITH A PARTIAL OR SMALLER UPPER LEVEL (SUCH AS A FRONT FACING GABLE) MAY BE ALLOWED TO HAVE A MINIMUM OF ONE WINDOW IN THE UPPER STORY AND THE WINDOW SHALL BE APPROPRIATE IN SIZE TO THE SCALE OF THE UPPER LEVEL MASS, MINIMUM OF 8 SQ.FT. OF GLASS.

B. WALL PLANE CHANGE:

WINDOW ARTICULATION THAT ADDS SHADOW AND VISUAL INTEREST IS ENCOURAGED.

THE WALL PLANE CHANGE SHALL BE PROPORTIONAL TO THE BUILDING ELEVATION, HAVE A DEPTH OF AT LEAST 12 INCHES, BE AT LEAST A FULL STORY IN HEIGHT, AND BE AT LEAST 6 FEET WIDE. RECESSED PLANES SHALL BE RECOGNIZABLE AS PART OF THE ELEVATION BEING ENHANCED.

EACH FRONT AND REAR ELEVATION SHALL INCLUDE MORE THAN ONE WALL PLANE,

OR, ON FRONT ELEVATIONS ONE WALL PLANE MAY BE ALLOWED WHEN ONE OR MORE OF THE FOLLOWING IS PROVIDED. (REFER TO IMAGE 1)

- 1. WINDOW(S) OR DOOR(S) EXCEEDING THE MINIMUM REQUIRED PER FLOOR. THE USE OF SHUTTERS MAY ALSO ENHANCE THE TOTAL SCALE OF FENESTRATION PROVIDED PER ELEVATION QUADRANT.
- 2. A PORCH OR STOOP THAT IS COVERED.
- 3. ROOF DORMERS.



IMAGE 1: WALL PLANE CHANGE EXAMPLES ON A FRONT ELEVATION

C. A VARIETY OF ROOF FORMS SHALL BE USED. SINGLE UNBROKEN ROOF PITCHES SHOULD BE AVOIDED EXCEPT WHERE A SINGLE ROOF TREATMENT IS AN ESSENTIAL ELEMENT OF THE ARCHITECTURAL STYLE. (E.G. MANSARD)

D. THE MAIN ROOF SHALL EXTEND BEYOND THE PRIMARY FACADE BY A MINIMUM OF 12 INCHES.

OR, ON HOMES WITH A ROOF PITCH OF 10:12 OR GREATER, A GABLE RAKE OF LESS THAN 12 INCHES MAY BE PERMITTED.

MODELS WITH GABLE RAKE OVERHANGS OF LESS THAN 12 INCHES SHALL NOT BE LOCATED DIRECTLY ACROSS THE STREET FROM EACH OTHER OR MORE THAN ONCE WITHIN EVERY 4 LOTS ON THE SAME SIDE OF ANY STREET.

CORRIDOR OR OPEN SPACE AREA SHALL PROVIDE AN "ENHANCED ELEVATION" WHICH FURTHER IMPROVES THE ARCHITECTURAL AESTHETIC OF THE RESIDENCE; AN ENHANCED ELEVATION SHALL PROVIDE THREE OF THE FOLLOWING DESIGN ENHANCEMENTS. THE DESIGN ENHANCEMENT SHALL BE APPLIED IN A MANNER THAT IS CONSISTENT WITH THE STYLE OF THE HOME. SIDE AND REAR ELEVATION DESIGN ENHANCEMENTS SHALL BE CONSISTENT WITH THE DESIGN ELEMENTS OF THE FRONT ELEVATION.

- 1. WINDOW(S) SHALL BE A MINIMUM OF 8 S.F. OF GLASS OR LARGER AT AN APPROPRIATE SCALE TO ADD CHARACTER TO THE ELEVATION.
- 2. A CHANGE IN WALL PLANE AS DEFINED IN SUBSECTION B ABOVE.
- 3. A PORCH, PATIO, OR DECK THAT IS COVERED.
- 4. THE USE OF ARCHITECTURAL DETAIL ELEMENTS SUCH AS SHUTTERS, VENTS, EAVE AND/OR GABLE BRACKETS, EXPOSED RAFTER TAILS, CORBELS, LINTELS, TRELLISES, COLUMNS OR PILASTERS, ADDITIONAL EXTERIOR ACCENT MATERIALS, ETC. WHICH IN COMBINATION CREATE AN ENHANCED ARCHITECTURAL STYLE.
- 5. THE USE OF TWO OR MORE EXTERIOR MATERIALS. ADDITIONAL MATERIALS SHOULD BE USED IN LOCATIONS WHERE IT IS LOGICAL AND APPROPRIATE AND SHOULD CONTINUE TO A NATURAL TRANSITION POINT. TO ACHIEVE THE ENHANCEMENT THE ADDITIONAL MATERIAL(S) SHALL BE USED TO COVER A MINIMUM OF 15% OF THE ELEVATION BEING ENHANCED. EXTERIOR MATERIALS MAY INCLUDE BUT ARE NOT LIMITED TO MASONRY (CULTURED STONE, STONE, BRICK, STUCCO, OR TILE), LAP SIDING, SHINGLES, BOARD AND BATTEN OR OTHER DECORATIVE SIDING TREATMENT. DIFFERENT APPLICATION STYLES OF THE SAME MATERIAL, FOR EXAMPLE THE APPLICATION OF LAP SIDING IN DIFFERENT WIDTHS, DOES NOT CONSTITUTE A SECOND MATERIAL
- F. COLUMNS OR POSTS EXTENDING MORE THAN 36 INCHES ABOVE THE GROUND WHICH SUPPORT STRUCTURAL ELEMENTS SUCH AS PORCHES. DECKS, OR ROOFS SHOULD APPEAR TO BE OF ADEQUATE MASS TO SUPPORT THE STRUCTURE ABOVE. (NO EXPOSED 4" X 4" POSTS SHALL BE ALLOWED MORE THAN 36 INCHES ABOVE THE GROUND). COLUMNS SUPPORTING UPPER STORY DECKS SHOULD BE 8" X 8" MINIMUM FINISHED

G. MATERIALS:

- 1. ALL EXTERIOR MATERIALS SHALL BE OF HIGH QUALITY, USED IN APPLICATIONS AND TREATED APPROPRIATELY TO PROVIDE AND ATTRACTIVE AND LONG LASTING APPEARANCE.
- 2. WHEN MASONRY IS USED IT SHOULD BE USED IN LOCATIONS WHERE ITS MASS IS LOGICAL AND APPROPRIATE. IN INSTANCES WHERE MASONRY WRAPS THE EXTERIOR CORNER OF THE HOME THE MASONRY SHOULD CONTINUE TO A NATURAL TRANSITION POINT SUCH AS THE INSIDE CORNER OF A PROJECTION WALL, A COLUMN, A DOOR OR WINDOW OR OTHER LOGICAL POINT. IN CASES WHERE NO SUCH FEATURE EXISTS NEAR THE CORNER, THE MASONRY WRAP SHALL EXTEND AT LEAST SIX FEET FROM THE CORNER.
- H. UTILIZE PASSIVE SOLAR CONCEPTS WHERE ARCHITECTURALLY APPROPRIATE AND IN ACCORDANCE WITH THE STYLE OF ARCHITECTURE.
 - 1. FOR EXAMPLE, EXTENDED OVERHANGS MAY BE IMPLEMENTED TO **BLOCK SUNLIGHT.**

III. BUILDING ORIENTATION

A. EACH DWELLING UNIT SHALL FACE THE FRONT LOT LINE OF THE PROPERTY AND HAVE AT LEAST 1 PRIMARY PEDESTRIAN DOORWAY FOR ACCESS TO THE DWELLING UNIT LOCATED ON, OR ADJACENT TO, THE ELEVATION OF THE DWELLING UNIT FACING THE FRONT LOT LINE OF THE PROPERTY. THE DOORWAY SHALL BE NO MORE THAN 20 FEET FROM THE MOST FORWARD PLANE OF THE FORWARD MOST LIVING SPACE WITHIN THE HOUSE AND SHALL BE CLEARLY ACCESSIBLE FROM THE STREET OR PUBLIC AREA ADJACENT TO THE FRONT LOT LINE (REFER TO IMAGE 2).

IN CONDITIONS WHERE SIDE LOADED GARAGES ARE UTILIZED, THE DOORWAY SHALL BE NO MORE THAN 20 'FROM THE FRONT FACING GARAGE WALL PLANE.

B. FOR SINGLE FAMILY FRONT LOADED LOTS ADJACENT TO STREETS ON TWO SIDES (CORNER LOTS), THE DWELLING MAY BE ORIENTED TO EITHER ADJACENT STREET AND THE PEDESTRIAN DOORWAY MAY THUS BE LOCATED FACING EITHER ADJACENT STREET.

IV. GARAGES, PORCHES AND STOOPS:

THESE REGULATIONS FOR GARAGES SHALL BE APPLIED TO NON-LIVING SPACE OR STORAGE AREAS WITHIN GARAGES WHETHER USED FOR STORAGE OF AUTOMOBILES OR OTHER ITEMS.

A. FRONT LOADED GARAGES:

- 1. GARAGES SHALL BE RECESSED A MINIMUM OF 8'-0" FROM THE FORWARD MOST FACADE, FRONT PORCH, OR COVERED STOOP, WHICHEVER LENGTH IS GREATEST, FOR FRONT LOADED LOTS 75' OR GREATER IN WIDTH.
- 2. GARAGES SHALL BE RECESSED A MINIMUM OF 2'-0" FROM THE FORWARD MOST FACADE, FRONT PORCH, OR COVERED STOOP, WHICHEVER LENGTH IS GREATEST, FOR FRONT LOADED LOTS BETWEEN 45' AND 74' FEET IN WIDTH.

B. SIDE LOADED GARAGES:

1. ON CORNER LOTS WHERE THE GARAGE IS ORIENTED TO THE SIDE LOT LINE RATHER THAN THE FRONT LOT LINE, THE GARAGE MUST BE SET BACK A MINIMUM OF 31' FROM THE FRONT STOOP OR PORCH OR FROM THE FORWARD MOST PLANE OF THE FRONT FACADE WHEN THERE IS NOT A STOOP OR PORCH.

C. ALLEY LOAD GARAGES:

1. GARAGES MUST BE ORIENTED TO AND ACCESSED FROM THE ALLEY WHEN THE DWELLING IS LOCATED ON A LOT WITH ALLEY ACCESS.

D. THREE OR MORE CAR GARAGE ORIENTATION:

WHEN GARAGE BAYS EXCEED TWO, THE ADDITIONAL GARAGE BAYS SHALL EITHER:

- 1. HAVE A DIFFERENT ORIENTATION FROM THE FIRST TWO:
- 2. SHALL BE RECESSED BEHIND THE FIRST TWO BY AT LEAST TWO FEET WHEN HAVING THE SAME ORIENTATION: OR
- 3. SHALL BE TANDEM TO THE FIRST TWO

E. FRONT STOOP

A FRONT STOOP IS COMPRISED OF STAIRS AND A PLATFORM WHICH PROVIDES ACCESS TO A FRONT DOOR WHEN THE THRESHOLD IS NOT AT GRADE AND MAY BE COVERED OR UNCOVERED. FOR DWELLING UNITS WITH A FRONT STOOP, THE FRONT STOOP PLATFORM SHALL BE AT LEAST 12 SQUARE FEET.

F. FRONT PORCHES

A FRONT PORCH IS COMPRISED OF STAIRS, PLATFORM, AND COLUMNS OR RAILING AND PROVIDES ACCESS TO A FRONT DOOR WHEN THE THRESHOLD IS NOT AT GRADE. A FRONT PORCH HAS A GENEROUS SIZED PLATFORM WHICH CREATES AN OUTDOOR LIVING SPACE AT THE FRONT OF THE HOUSE. FOR DWELLING UNITS WITH A FRONT PORCH, THE FRONT PORCH SHALL BE AT LEAST 60 SQUARE FEET, AND SHALL HAVE A MINIMUM DEPTH OF 6 FEET AS MEASURED FROM THE STUD WALL TO THE COLUMN CENTERLINE OR RAILING. (REFER TO IMAGE 2)

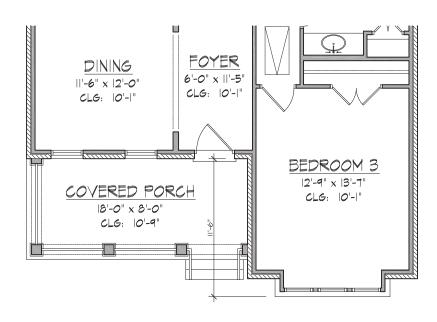




IMAGE 2: FRONT PORCH AND FRONT DOOR DEPTH

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DEIACIE DEVELOPMENT **FAMILY** SINGL

DRAWN BY: CGR **DESIGNED BY:** BC/SW

> SUBMITTED ON: 2/09/2023

A PARCEL OF LAND LOCATED IN SECTION 16, TOWNSHIP 1 NORTH, RANGE 68 WEST OF THE SIXTH PRINCIPAL MERIDIAN, TOWN OF ERIE, COUNTY OF WELD, STATE OF COLORADO 390.8797 ACRES

PD-001700-2024

SINGLE FAMILY ATTACHED DEVELOPMENT STANDARDS

II. ARCHITECTURAL CHARACTER

A. INTENT

- TO IMPROVE THE APPEARANCE OF DUPLEX AND TOWNHOME AREAS THROUGH THE INCORPORATION OF ARCHITECTURAL DETAILING, FACADE ARTICULATION, AND OTHER FEATURES DESIGNED TO PROVIDE A MORE DISTINCT CHARACTER AND HUMAN SCALE FOR BUILDINGS OF ALL SIZES.
- 2. TO ENCOURAGE THE USE OF ARCHITECTURAL STYLES THAT REINFORCES THE TOWN'S TRADITIONAL CHARACTER.

B. DESIGN STANDARDS

- 1. ALL SIDES OF A DUPLEX OR TOWNHOME BUILDING SHALL DISPLAY A SIMILAR LEVEL OF OUALITY AND ARCHITECTURAL DETAILING. THE MAJORITY OF A BUILDING'S ARCHITECTURAL FEATURES AND TREATMENTS SHALL NOT BE RESTRICTED TO A SINGLE FACADE. BUILDING DETAILS, INCLUDING ROOF FORMS, WINDOWS, DOORS, TRIM, AND SIDING MATERIALS, SHALL REFLECT THE ARCHITECTURAL STYLE OF THE BUILDING.
- 2. ATTACHED DWELLING UNITS MAY EITHER EXPRESS EACH INDIVIDUAL UNIT OR GIVE EACH BUILDING THE APPEARANCE OF A LARGE SINGLE-FAMILY HOME.
- 3. THE INCORPORATION OF A VARIETY OF ROOF FORMS IS STRONGLY ENCOURAGED ON DIFFERENTIATED DWELLING UNITS. GENERALLY, DUPLEX OR TOWNHOMES SHALL INCORPORATE ROOF PITCHES OF BETWEEN 3:12 AND 6:12; HOWEVER, ALTERNATIVE ROOF FORMS MAY BE PERMITTED AT THE DISCRETION OF THE DIRECTOR OF PLANNING AND DEVELOPMENT.
- 4. ROOF OVERHANGS SHALL EXTEND BEYOND THE PRIMARY FACADE BY A MINIMUM OF 12 INCHES.

OR, ON HOMES WITH A ROOF PITCH OF 10:12 OR GREATER, A GABLE RAKE OF LESS THAN 12 INCHES MAY BE PERMITTED.

MODELS WITH GABLE RAKE OVERHANGS OF LESS THAN 12 INCHES SHALL NOT BE PLACED ADJACENT TO OR ACROSS THE STREET FROM 1 ANOTHER.

- 5. HORIZONTAL AND VERTICAL VARIATIONS IN MATERIALS ALONG THE FACADE OF A DUPLEX OR TOWNHOME BUILDING SHALL OCCUR IN CONJUNCTION WITH A CHANGE IN WALL PLANE, PREFERABLY AT THE INSIDE CORNER OF A WALL
- 6. THE MAXIMUM LENGTH OF ANY TOWNHOME BUILDING SHALL BE 156 FEET.

C. MATERIALS

1. INTENT

a. TO MAXIMIZE THE QUALITY, VALUE, AND LONGEVITY OF NEIGHBORHOODS THROUGH THE USE OF DURABLE MATERIALS THAT WILL MINIMIZE MAINTENANCE COSTS AND IMPROVE THE OVERALL APPEARANCE OF THE DEVELOPMENT.

b. TO ENCOURAGE THE USE OF RECYCLED AND OTHER ENVIRONMENTALLY-FRIENDLY, LEADERSHIP IN ENERGY AND ENVIRONMENTAL DESIGN (LEED) CERTIFIED BUILDING MATERIALS.

- c. UTILIZE PASSIVE SOLAR CONCEPTS WHERE ARCHITECTURALLY
- i. FOR EXAMPLE, EXTENDED OVERHANGS MAY BE IMPLEMENTED TO BLOCK SUNLIGHT.

2. DESIGN STANDARDS

- CONSTRUCTED FROM DURABLE MATERIALS WITH PRODUCT WARRANTIES OR AN INDUSTRY EXPECTED LIFE OF A MINIMUM OF 25-YEARS.
- b. EXTERIOR INSULATING AND FINISH SYSTEM (EIFS) SHALL NOT BE PERMITTED.
- ROOFING MATERIALS WITH PRODUCT WARRANTIES OR AN INDUSTRY EXPECTED LIFE OF A MINIMUM OF 25 YEARS.

- 1. TO ORGANIZE THE PRIMARY ENTRANCES AND FACADES OF DUPLEX OR TOWNHOME BUILDINGS WITH A CLEAR ORIENTATION TOWARDS A STREET,
- 2. TO CREATE AN INTEGRATED NEIGHBORHOOD APPEARANCE FOR DUPLEX AND TOWNHOME AREAS THAT ESTABLISHES A PATTERN THAT IS INTEGRATED WITH ADJACENT USES INSTEAD OF SEGREGATED AS A SEPARATE SUB-COMMUNITY.

B. DESIGN STANDARDS

- PARKS, OR ON-SITE NATURAL AREAS OR FEATURES WITH A CLEARLY
- 2. PRIMARY FACADES SHALL NOT BE ORIENTED TOWARDS ALLEYS, PARKING LOTS,

APPROPRIATE AND IN ACCORDANCE WITH THE STYLE OF ARCHITECTURE.

- a. PRIMARY EXTERIOR BUILDING MATERIALS ON STRUCTURES SHALL BE
- c. ALL STRUCTURES SHALL UTILIZE DURABLE, ENVIRONMENTALLY SENSITIVE

III. BUILDING ORIENTATION

A. INTENT

- GARDEN COURT, OR POCKET PARK,

- 1. THE PRIMARY FACADE OF INDIVIDUAL BUILDINGS SHALL BE ORIENTED **TOWARDS:**
 - a. STREETS, OR
 - b. COMMON OPEN SPACE/GARDEN COURTS, SUCH AS INTERIOR COURTYARDS, DEFINED AND EASILY ACCESSIBLE PEDESTRIAN CIRCULATION SYSTEM.
- GARAGES, OR CARPORTS.

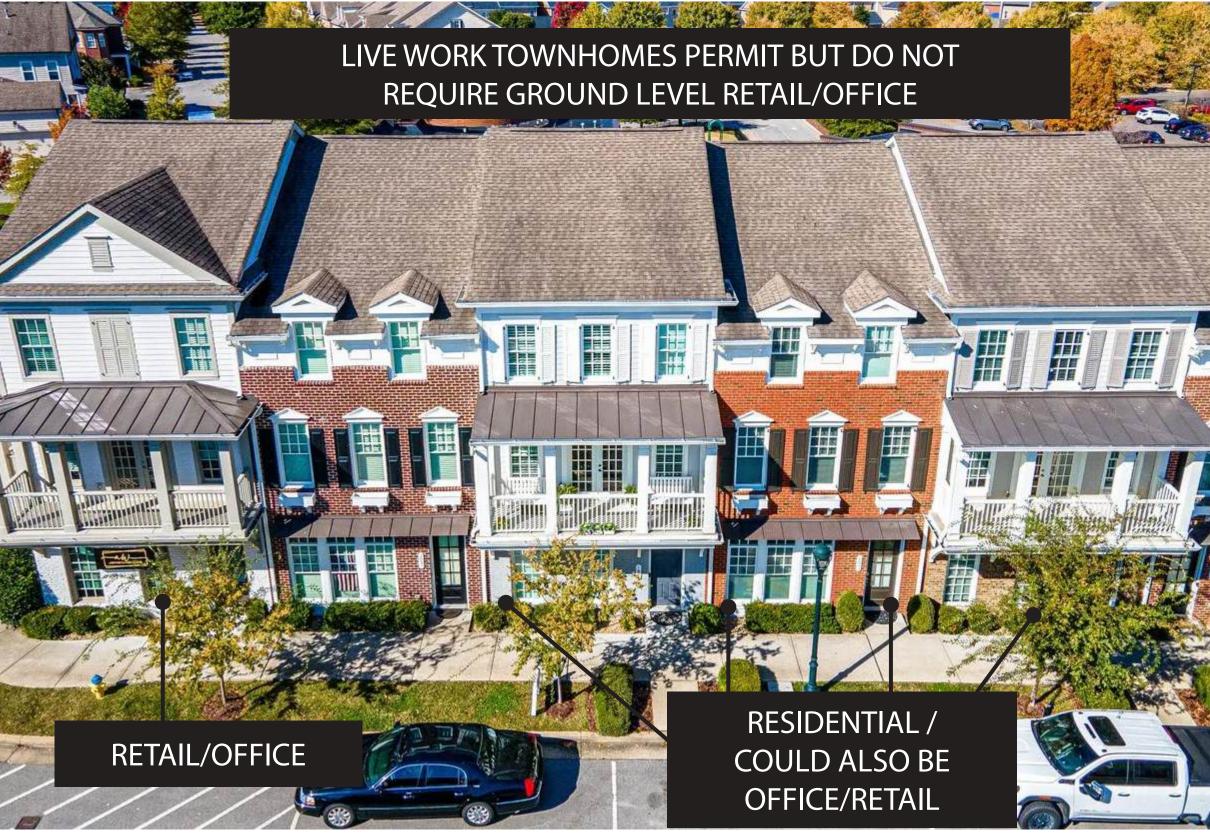


IMAGE ABOVE: LIVE-WORK TOWNHOMES

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C. DUPLEXES

- 1. A CONTINUOUS ROW OF IDENTICAL HOMES ALONG A BLOCK SHALL BE PROHIBITED. INDIVIDUAL STRUCTURES SHALL BE DIFFERENTIATED THROUGH TWO OR MORE OF THE FOLLOWING METHODS:
 - a. USE OF DISTINCT COLOR VARIATION AND MATERIALS BETWEEN INDIVIDUAL STRUCTURES;
 - b. USE OF DISTINCT VARIATIONS IN ROOF FORM, OR

SINGLE FAMILY ATTACHED ARCHITECTURAL STANDARDS

SURROUNDING BUILDING GROUPINGS.

SINGLE ROW OR BUILDING CLUSTER.

DESIGN THROUGH THE FOLLOWING:

DWELLING UNITS:

FOLLOWING METHODS,

INDIVIDUAL DWELLING UNITS;

iv. USE OF DISTINCT VARIATIONS IN ROOF FORM,

MORE METHODS,

AMENDED FROM TIME TO TIME.

A. INTENT

I. ARCHITECTURAL VARIETY

B. TOWNHOMES

THE PURPOSE OF THESE BUILDING DESIGN AND CHARACTER STANDARDS ARE TO ESTABLISH

A MORE PREDICTABLE APPROACH TO DUPLEX AND TOWNHOME AREAS THAT ENCOURAGES

STANDARDS SHALL APPLY TO ALL SINGLE FAMILY ATTACHED TYPES INCLUDING DUPLEX

FRONT-LOAD, DUPLEX ALLEY-LOAD, TOWNHOUSE FRONT-LOAD, TOWNHOUSE ALLEY-LOAD

AND LIVE-WORK TOWNHOMES. THE SINGLE FAMILY ATTACHED ARCHITECTURAL STANDARDS REPLACE SECTIONS 10.6.7 OF THE ERIE UNIFIED DEVELOPMENT CODE, AS THE SAME MAY BE

. TO ENSURE THAT INDIVIDUAL GROUPINGS OF DUPLEX OR TOWNHOME

2. TO AVOID THE BLEAK, "BARRACKS-TYPE" APPEARANCE ASSOCIATED WITH

LARGE CONCENTRATIONS OF IDENTICAL OR VERY SIMILAR STRUCTURES.\

1. NO MORE THAN 6 TOWNHOME DWELLING UNITS MAY BE ATTACHED IN ANY

2. WITHIN EACH TOWNHOME ROW OR CLUSTER, INDIVIDUAL DWELLING UNITS

SHALL EITHER BE DIFFERENTIATED OR MAY EXPRESS A PURPOSELY UNIFORM

a. WHEN INDIVIDUAL DWELLING UNITS OF A TOWNHOME BUILDING ARE TO BE

DIFFERENTIATED, DWELLING UNITS SHALL USE THE FOLLOWING TWO OR

i. USE OF DISTINCT COLOR VARIATION BETWEEN INDIVIDUAL DWELLING

ii. USE OF DISTINCT VARIATIONS IN MATERIALS BETWEEN INDIVIDUAL

FEATURES, SUCH AS A PORCH OR SIMILAR FEATURE, BETWEEN

v. A VARIATION IN THE PLANE OF THE FRONT FACADE TO PROVIDE A

MINIMUM 1 FOOT VARIATION BETWEEN INDIVIDUAL DWELLING UNITS.

iii. USE OF DISTINCT VARIATIONS IN ARCHITECTURAL STYLE OR

b. WHEN UNIFORMITY OF INDIVIDUAL DWELLING UNITS OF A TOWNHOME

BUILDING TO APPEAR AS A LARGE SINGLE FAMILY HOME, THIS SHALL

BE EXPRESSED THROUGH REPETITION OF THREE OR MORE OF THE

i. USE OF MATERIALS BOTH IN TYPE AND LOCATION;

ii. SIZE, STYLE, AND PATTERNING OF WINDOWS:

iv. ROOF DORMERS, ROOF FORM, AND ROOF PITCH

iii. SIZE AND DETAILING OF FRONT PORCHES;

BUILDINGS WITHIN A LARGER DEVELOPMENT EXHIBIT A DISTINCT VARIATION

IN SIZE AND MASS THAT ALLOWS THEM TO BE EASILY DISTINGUISHED FROM

CREATIVITY IN DESIGN FOR INDIVIDUALISM OF BUILDINGS OR DWELLING UNITS THAT RESULTS

IN ATTRACTIVE, LONG-LASTING NEIGHBORHOODS. SINGLE FAMILY ATTACHED ARCHITECTURAL

c. USE OF DISTINCT VARIATIONS IN ARCHITECTURAL FEATURES, SUCH AS PORCHES, ROOF FORM, WINDOWS, OR SIMILAR FEATURE, BETWEEN INDIVIDUAL STRUCTURES.

2. VARIETY

- a. NO IDENTICAL MODEL PLAN ELEVATION SHALL BE REPEATED DIRECTLY ACROSS ANY STREET FROM THE SAME MODEL PLAN AND ELEVATION.
- b. NO IDENTICAL MODEL PLAN ELEVATION SHALL BE REPEATED MORE THAN ONCE WITHIN EVERY 4 LOTS ON THE SAME SIDE OF ANY STREET.
- c. A MINIMUM OF 3 RECOGNIZABLY DIFFERENT MODEL PLANS WITH 3 RECOGNIZABLY DIFFERENT ELEVATIONS BE SUBMITTED TO THE TOWN FOR REVIEW.

D. TRACKING

1. IT SHALL BE THE RESPONSIBILITY OF THE DEVELOPER TO PROVIDE TO THE TOWN A PLAT SHEET TRACKING DOCUMENT THAT MAINTAINS A RECORD OF HOME MODEL VARIETY FOR EVERY DEVELOPMENT PARCEL. THE DEVELOPER SHALL DEMONSTRATE COMPLIANCE WITH THIS SECTION PRIOR TO ISSUANCE OF A BUILDING PERMIT.

A PARCEL OF LAND LOCATED IN SECTION 16, TOWNSHIP 1 NORTH, RANGE 68 WEST OF THE SIXTH PRINCIPAL MERIDIAN, TOWN OF ERIE, COUNTY OF WELD, STATE OF COLORADO

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MULTI-FAMILY DEVELOPMENT STANDARDS

- e. STUCCO OR SYNTHETIC STUCCO
- f. PRE-CAST CONCRETE, INTEGRALLY COLORED
- 2. THE FOLLOWING MATERIALS MAY BE USED AS AN ACCENT MATERIAL IN CONJUNCTION WITH A PRIMARY MATERIAL FROM ABOVE:
 - a. ORNAMENTAL METAL
 - b. ARCHITECTURAL TILE
 - c. WOOD
- 3. BRICK, STONE, STUCCO OR OTHER MASONRY MATERIALS SHALL BE USED ON A MINIMUM OF 30 PERCENT OF ALL EXTERIOR WALLS FACING PUBLIC RIGHT-OF-WAY. THE TOTAL AREA OF THE WALL TO WHICH THE 30 PERCENT REQUIREMENT APPLIES SHALL NOT INCLUDE AREAS OF GLAZING (E.G., WINDOWS) AND ENTRYWAYS.
- 4. ACCESSORY BUILDINGS SHALL BE FINISHED IN THE SAME MATERIALS AS THE PRINCIPAL BUILDING AND SHOULD BE LOCATED TO THE SIDE OR REAR OF THE PRINCIPAL BUILDING.
- D. ENTRIES. THE ENTRANCE TO ALL BUILDINGS SHALL BE CLEARLY DEFINED AND INTEGRATED INTO THE BUILDING DESIGN THROUGH THE FOLLOWING TECHNIQUES:
 - 1. THE ENTRY SHALL BE PEDESTRIAN IN SCALE AND DESIGNED TO ENCOURAGE ACTIVITY AND SIGNALIZE BUILDING ENTRY POINTS
 - 2. LANDSCAPE AREAS SHALL BE ORIENTED AND FOCUSED ON THE ENTRANCE
 - 3. MAIN ENTRIES SHALL BE ORIENTED TOWARDS THE PRIMARY STREET
 - 4. USE OF CREATIVE ENTRY TREATMENTS SUCH AS CANOPIES, AWNINGS, CORNICE TREATMENTS OR ATRIUM
 - 5. USE OF INTEGRATED SIGNAGE
- E. UTILIZE PASSIVE SOLAR CONCEPTS WHERE ARCHITECTURALLY APPROPRIATE AND IN ACCORDANCE WITH THE STYLE OF ARCHITECTURE.
 - 1. FOR EXAMPLE, EXTENDED OVERHANGS MAY BE IMPLEMENTED TO BLOCK SUNLIGHT.








IMAGES ABOVE: EXAMPLES OF MULTI-FAMILY ARCHITECTURAL CHARACTER





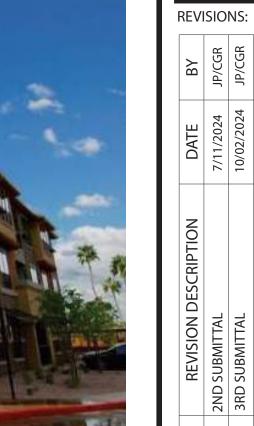

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SUBMITTED ON: 2/09/2023

MULTI-FAMILY ARCHITECTURAL STANDARDS

MULTI-FAMILY ARCHITECTURAL STANDARDS SHALL APPLY TO ALL APARTMENTS OR MULTI-FAMILY DWELLING UNITS. MULTI-FAMILY ARCHITECTURAL STANDARDS REPLACE SECTIONS 10.6.7 OF THE ERIE UNIFIED DEVELOPMENT CODE, AS THE SAME MAY BE AMENDED FROM TIME TO TIME.

- I. GENERAL MULTI-FAMILY STANDARDS
- A. STAIRWAYS SHALL NOT BE LOCATED OUTSIDE OF THE BUILDING ENVELOPE.
- II. ARCHITECTURAL CHARACTER
 - A. BUILDING MASS
 - 1. BUILDINGS AND ARCHITECTURAL FACADES SHALL BE ORIENTED TO CREATE A PEDESTRIAN-ORIENTED, ATTRACTIVE STREETSCAPE WITH OUTDOOR ROOMS, SUCH AS ATRIUMS, COURTYARDS, COLONNADES, TRELLISES, PLAZAS, PROMENADES, ETC.
 - 2. EACH PRIMARY BUILDING TALLER THAN 38' IN HEIGHT SHALL BE DESIGNED SO THAT THE MASSING OR FACADE ARTICULATION COMPONENTS OF THE BUILDING PRESENTS A CLEAR BASE, MIDDLE, AND TOP. THE BASE OR GROUND FLOOR ELEVATION SHALL BE APPROPRIATELY ARTICULATED TO PROVIDE HUMAN SCALE.
 - 3. LONG, UNARTICULATED FACADES SHALL BE AVOIDED BY EMPLOYING ANY COMBINATION OF THE FOLLOWING TO CREATE VISUAL INTEREST AND SHADOW LINES. BUILDINGS HAVING SINGLE WALLS EXCEEDING 50' IN LENGTH SHALL INCORPORATE AT A MINIMUM TWO (2) OF THE FOLLOWING FOR EVERY 50':
 - a. PROJECTIONS OF EXTERIOR BUILDING WALLS, RECESSES AND REVELS IN EXTERIOR BUILDING WALLS A MINIMUM OF 1'
 - b. VARIATIONS IN COLOR
 - c. WINDOW FENESTRATION
 - d. ROOF OVERHANGS
 - e. CHANGES IN PARAPET HEIGHT
 - f. ARCADE, PERGOLAS, TRELLISES
 - g. TOWERS
 - h. GABLE PROJECTIONS
 - TEXTURED AND/OR PATTERNED SURFACES

B. ROOF LINE

- 1. ROOFS ARE TO BE A PROMINENT AND COMPLIMENTARY ELEMENT TO THE BUILDING ARCHITECTURE. IT IS IMPORTANT THAT ROOF FORMS AND VARIATIONS IN PLANES ARE INCORPORATED INTO EACH BUILDING ELEVATION.
- 2. BUILDINGS WITH FLAT ROOFS SHALL BE DESIGNED TO CREATE VISUAL INTEREST BY USING VARIATIONS IN PARAPET HEIGHT IN VARIOUS AREAS.
- 3. INTENSE, BRIGHT OR FLUORESCENT COLORS SHALL NOT BE USED ON ANY ROOF AREAS VISIBLE FROM PUBLIC OR PRIVATE RIGHT-OF-WAY OR PUBLIC OPEN SPACE.
- 4. WHEN SLOPING ROOFS ARE USED, AT LEAST ONE OF THE FOLLOWING ELEMENTS SHALL BE INCORPORATED INTO THE DESIGN FOR EACH 60 LF OF
 - a. PROJECTING GABLES
 - b. HIPS
 - c. HORIZONTAL OR VERTICAL BREAKS
 - d. ALTERNATING ROOF PITCHES
- 5. ALL ROOFTOP MECHANICAL EQUIPMENT AND VENTS GREATER THAN EIGHT INCHES IN DIAMETER SHALL BE SCREENED. SCREENING MAY BE DONE EITHER WITH AN EXTENDED PARAPET WALL OR A FREE-STANDING SCREEN WALL. SCREENS SHALL BE AT A MINIMUM AS TALL AS THE EQUIPMENT THAT THEY HIDE. COLOR AND MATERIALS SHOULD BE COMPATIBLE TO THE ARCHITECTURE OF THE PRINCIPAL STRUCTURE.

C. MATERIALS

- 1. DIVERSITY IN MATERIALS IS REQUIRED AND A MINIMUM OF TWO (2) DIFFERENT MATERIALS SHALL BE INCORPORATED INTO EACH BUILDING. THESE MATERIALS SHOULD BE USED TO CREATE BASES, SECONDARY FIELDS, OR ACCENT BANDING. BANDING SHALL BE USED TO DIFFERENTIATE BETWEEN A BASE, MIDDLE AND TOP. THE FOLLOWING PRIMARY MATERIALS ARE PERMITTED:
 - a. BRICK OR THIN SET BRICK
 - b. CAST STONE OR SYNTHETIC STONE
 - c. INTEGRALLY COLORED PRE-CAST CONCRETE
 - d. INTEGRALLY COLORED CONCRETE MASONRY UNITS, SPLIT FACED BLOCK, GROUNDFACE CMU

A PARCEL OF LAND LOCATED IN SECTION 16, TOWNSHIP 1 NORTH, RANGE 68 WEST OF THE SIXTH PRINCIPAL MERIDIAN,
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COMMERCIAL DEVELOPMENT STANDARDS

COMMERCIAL DEVELOPMENT STANDARDS

THE COMMERCIAL DEVELOPMENT STANDARDS SHALL APPLY TO ALL NON-RESIDENTIAL DEVELOPMENT INCLUDING MIXED-USE, COMMERCIAL AND PUBLIC/INSTITUTIONAL, AND COMMUNITY AMENITY. THE COMMERCIAL DEVELOPMENT STANDARDS REPLACE SECTIONS 10.6.4 LANDSCAPING, SCREENING, FENCES; 10.6.8 COMMERCIAL AND PUBLIC/INSTITUTIONAL USE CATEGORIES, MIXED-USE DESIGN STANDARDS; 10.6.10 EXTERIOR LIGHTING OF THE ERIE UNIFIED DEVELOPMENT CODE, AS THE SAME MAY BE AMENDED FROM TIME TO TIME.

I. GENERAL COMMERCIAL SITE STANDARDS

A. PARKING LOT SCREENING

- 1. THE CIRCULATION SYSTEM WITHIN COMMERCIAL DEVELOPMENTS, INCLUDING PARKING LOTS, SHALL CONTRIBUTE TO THE ORDER AND AESTHETIC QUALITY OF THE SITE. AESTHETICS, COMPATIBILITY WITH THE OVERALL SITE DESIGN, CONVENIENCE AND SAFETY FOR USERS AND PEDESTRIANS MUST BE CONSIDERED IN PARKING LOT DESIGN.
- 2. PARKING LOTS SHOULD BE SCREENED FROM VIEW FROM PUBLIC STREETS BY USE OF LANDSCAPED BUFFERS, BERMS, OR OTHER SCREENS AS APPROVED. CONTINUOUS SCREENING 30-INCHES IN HEIGHT IS REQUIRED UNLESS AN ALTERNATIVE SCREEN IS APPROVED. ALTERNATIVE LANDSCAPE SCREENING MAY INCLUDE UPRIGHT EVERGREEN TREES OR OTHER TREES OR SHRUBS. PARKING LOT EDGES SHOULD BE TREATED WITH AN AESTHETIC LANDSCAPE TREATMENT.
- 3. PEDESTRIAN CONNECTIVITY SHOULD BE PROVIDED BETWEEN THE PARKING, THE BUILDINGS. AND TO MAJOR TRAIL CONNECTIONS.

B. LOADING DOCK SCREENING

1. LOADING DOCKS SHOULD BE SCREENED BY USE OF OPAQUE FENCES, WALLS OR LANDSCAPED BUFFERS, BERMS OR OTHER ALTERNATIVE SCREENS AS APPROVED. SCREENS SHALL BE HIGH ENOUGH TO HIDE DELIVERY AREAS FROM PUBLIC STREETS AND ADJACENT PROPERTIES. ALTERNATIVE LANDSCAPE SCREENING MAY INCLUDE UPRIGHT EVERGREEN TREES OR OTHER TREES OR SHRUBS AS APPROVED.

II. COMMERCIAL ARCHITECTURAL STANDARDS

A. BUILDING MASS


- 1. COMMERCIAL BUILDINGS SHALL ACHIEVE A HUMAN SCALE APPROPRIATE TO THE SITE AND FUNCTION OF THE PROJECT. BUILDING MASS SHALL CREATE HARMONIOUS TRANSITIONS IN SCALE AND CHARACTER IN AREAS BETWEEN DIFFERENT LAND USES. ARCHITECTURAL QUALITY AND OVERALL DESIGN SHALL BE COMPATIBLE WITH THE SITE LOCATION AND PROPOSED USE AS DEMONSTRATED BY BUILDING ELEVATIONS. DIVERSE ARCHITECTURAL TREATMENTS SHALL BE INTEGRATED TO AVOID A CLUTTERED APPEARANCE.
- 2. BUILDINGS ADJACENT TO "MAIN STREET" (AS DEFINED IN THE CONCEPT PLAN) SHALL BE CLOSE TO THE ROADWAY AND SHALL HAVE A SIMILAR LEVEL OF DETAIL AND FENESTRATION ON ALL SIDES OF THE BUILDING THAT ARE VISIBLE TO THE STREET, MAIN PEDESTRIAN WALKWAYS, OR PARKING AREAS.
- 3. COMMERCIAL BUILDINGS SHALL PROVIDE ARTICULATION BY APPLYING AT LEAST FOUR (4) OF THE FOLLOWING TREATMENTS TO ALL EXTERIOR WALLS:
 - a. VARIATIONS IN HEIGHT
 - b. OFFSETS IN WALL PLANE
 - c. VARIATIONS IN ROOF LINE
 - d. CORNICE TREATMENTS
 - e. RECESSED OR PROJECTED ENTRYWAYS
 - f. RECESSED WINDOWS
 - g. CANOPIES OR AWNINGS
 - h. MORE THAN ONE FINISH MATERIAL
 - i. MORE THAN ONE COLOR
 - j. OTHER ARCHITECTURAL DETAILS THAT PREVENT THE APPEARANCE OF MASSIVE AND FEATURELESS WALLS

B. EXTERIOR FINISH MATERIALS.

- 1. ALL EXTERIOR MATERIALS SHALL BE OF HIGH QUALITY SUCH THAT THEY ARE DURABLE, EASY TO MAINTAIN, AND PROVIDE FOR A LONGEVITY OF USE. BUILDING BASE MATERIALS SHALL BE MASONRY. BRICK, STONE, STUCCO, OR OTHER APPROVED MASONRY MATERIALS SHALL BE USED ON A MINIMUM OF 30 PERCENT OF ALL EXTERIOR WALLS.
- 2. THE SECONDARY EXTERIOR WALL MATERIAL USED FOR THE SIDE WALLS, BACKS WALLS, AND INFILL WALLS MAY BE FINISHED ARCHITECTURAL BLOCK, COMPOSITE SIDING, OR TREATED WOOD. THE PREFERRED ACCENT MATERIALS FOR INCORPORATION INTO THE BASIC EXTERIOR FACADES SHALL INCLUDE STUCCO, STONE, TILE, OR PRE-FINISHED METAL.

3. THE FOLLOWING MATERIALS ARE PROHIBITED:

- a. ALUMINUM SIDING OR CLADDING (COMPOSITE ALUMINUM ALLOWED AT CANOPIES AND ENTRANCES)
- b. PLASTIC OR VINYL SIDING
- c. UNFINISHED CONCRETE MASONRY UNITS OR CONCRETE WALL
- d. SHIPPING CONTAINERS OR CONEX BOXES
- e. REFLECTIVE GLASS
- C. UTILIZE PASSIVE SOLAR CONCEPTS WHERE ARCHITECTURALLY APPROPRIATE AND IN ACCORDANCE WITH THE STYLE OF ARCHITECTURE.
 - 1. FOR EXAMPLE, EXTENDED OVERHANGS MAY BE IMPLEMENTED TO BLOCK SUNLIGHT.
- D. ACCESSORY BUILDINGS. ACCESSORY BUILDING SHALL BE FINISHED IN THE SAME MATERIALS AS THE PRINCIPAL BUILDING.
- E. SHOPPING CENTERS. BUILDINGS THAT SHARE COMMON PARKING AREAS OR DRIVEWAYS SHOULD ALSO SHARE EXTERIOR DESIGN ELEMENTS AND FINISH MATERIALS.
- F. CORPORATE IDENTITY. IT IS RECOGNIZED THAT MANY CORPORATIONS HAVE IDENTIFIABLE CORPORATE ARCHITECTURE. THIS IS NOT PROHIBITED BUT SHOULD BE MODIFIED, IF NECESSARY, TO BE COMPATIBLE WITH THE LOCATION OF THE PROPOSED BUILDING AND CONSISTENT WITH THESE DESIGN STANDARDS.
- G. BUILDING ADDITIONS. POST DEVELOPMENT, THESE STANDARDS SHALL APPLY TO ADDITIONS TO EXISTING BUILDINGS. THE EXTERIOR TREATMENT OF ANY BUILDING ADDITIONS SHALL, TO THE EXTENT PRACTICAL AND FEASIBLE, BE OF THE SAME MATERIALS AND COLORS AS THE EXISTING STRUCTURE.
- H. EXTERIOR REMODEL. POST DEVELOPMENT, ANY FUTURE MODIFICATION TO THE EXTERIOR OF EXISTING BUILDINGS WHICH REQUIRES A BUILDING PERMIT WILL BE SUBJECT TO THE STANDARDS SET OUT IN THIS PD.
- I. DRIVE THROUGH THE FOLLOWING STANDARDS SHALL APPLY.
 - 1. THE DRIVE THROUGH SHALL NOT BE VISIBLE FROM THE PRIMARY STREET FRONTAGE.
 - 2. IN GENERAL, PARKING LOTS AND STACKING LANES SHALL BE LOCATED AWAY FROM AND OUT OF SIGHT OF THE PUBLIC RIGHT-OF-WAY.
 - 3. PARKING ACCESS POINTS, WHETHER LOCATED IN FRONT, SIDE, OR REAR, SHALL BE LOCATED AS FAR AS POSSIBLE FROM STREET INTERSECTIONS TO ALL ADEQUATE STACKING ROOM.
 - 4. STRUCTURES AND ON-SITE CIRCULATION SYSTEMS SHOULD BE LOCATED TO MINIMIZE PEDESTRIAN AND VEHICLE CONFLICTS.
 - 5. RECIPROCAL ACCESS BETWEEN ADJACENT PARKING AREAS SHALL BE PROVIDED WHERE FEASIBLE SO THAT VEHICLES ARE NOT REQUIRED TO ENTER THE STREET IN ORDER TO MOVE FROM ONE AREA TO ANOTHER ON THE SAME OR ADJACENT SITES.
 - 6. CURB-CUTS SHOULD BE MINIMIZED TO REDUCE PEDESTRIAN CONFLICTS ALONG THE STREET AND ENCOURAGE WALKABILITY AND ACCESSIBILITY.
 - 7. DRIVEWAYS OR SITE ACCESS SHOULD BE PROVIDED ON NON-RESIDENTIAL SIDE STREETS OR LESS MAJOR STREETS WHERE POSSIBLE TO IMPROVE PEDESTRIAN SAFETY AND REDUCE PEDESTRIAN AND VEHICLE CONFLICTS OR VEHICLE STACKING ON MAJOR STREETS.
 - 8. WALLS AND SCREENING SHOULD BE USED TO HIDE ANY DRIVE-THROUGH LOCATED ADJACENT TO "MAIN STREET" AS IDENTIFIED IN THE CONCEPT PLAN.

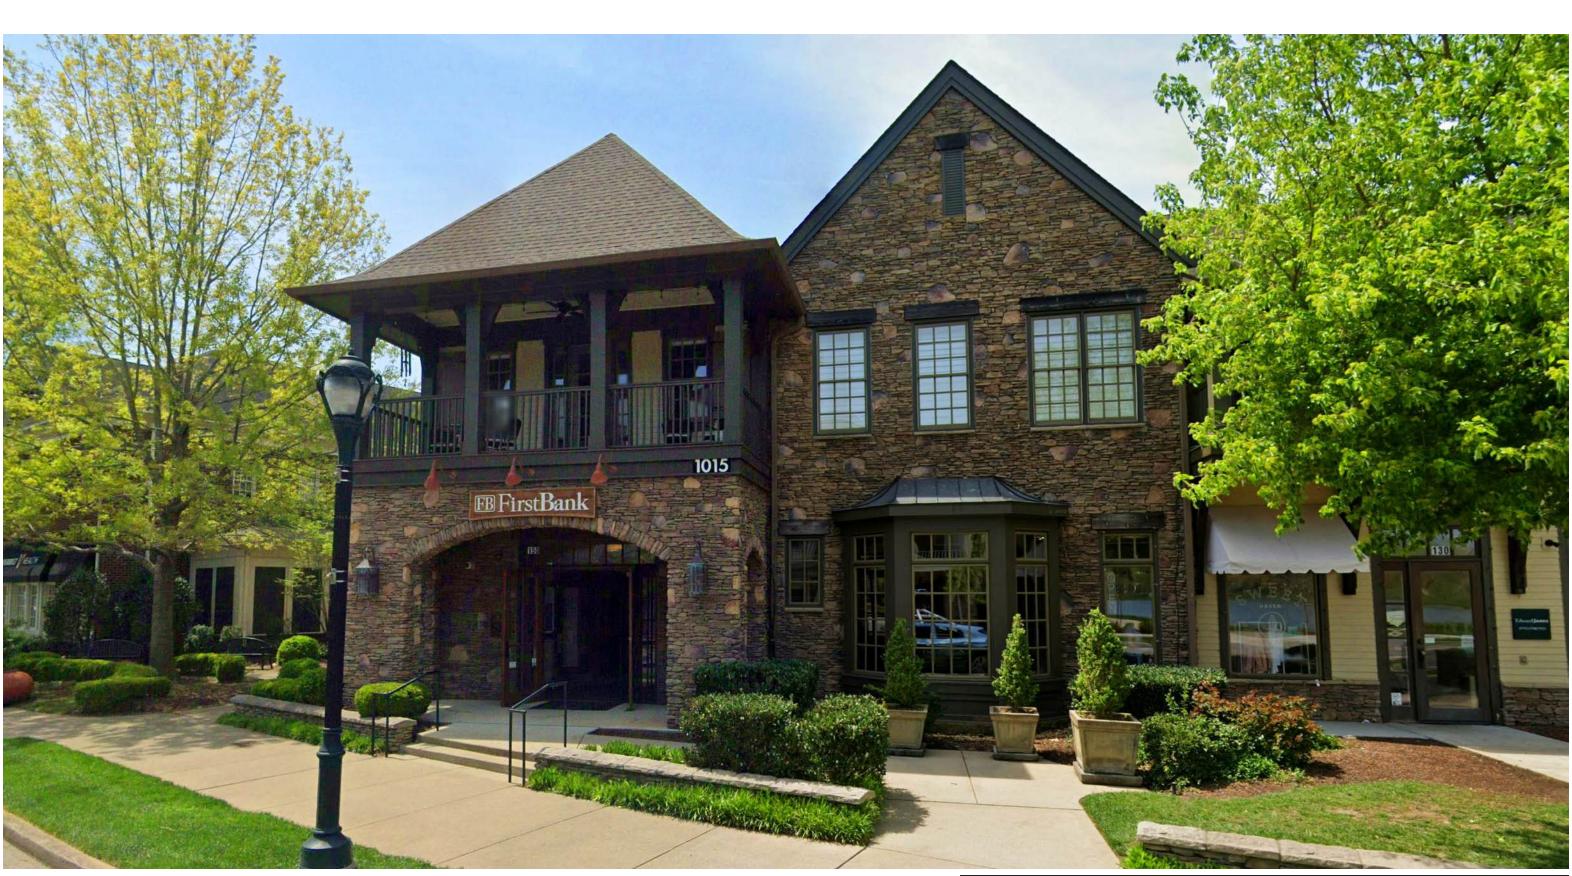

WE ARE PROVIDING THIS EXAMPLE OF HOW A DRIVE THROUGH FOR A BANK HAS BEEN SUCCESSFULLY INTEGRATED INTO THE PEDESTRIAN COMMERCIAL MIXED-USE ENVIRONMENT IN SOUTHERN LANDS WESTHAVEN COMMUNITY.


BANK - FRONT STREET VIEW

PREPARED FOR:

NORTH WESTERLY
OWNER, LLC
3990 HILLSBORO PIKE.

SUITE 400,
NASHVILLE, TN 37215
720-531-8924
CONTACT: JIM HENRY

ENGINEERING:

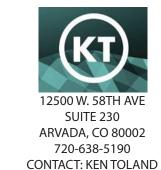

LAND PLANNING:

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3990 HILLSBORO PIKE, SUITE 400, NASHVILLE, TN 37215 615.778.2884 CONTACT:



720-259-8246

CONTACT:

JOHN PRESTWICH

REV	ISIO	NS:			
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SHEET INFO:

COMMERCIAL DEVELOPMENT STANDARDS

DRAWN BY:

CGR

DESIGNED BY:

BC/SW

SUBMITTED ON: 2/09/2023

A PARCEL OF LAND LOCATED IN SECTION 16, TOWNSHIP 1 NORTH, RANGE 68 WEST OF THE SIXTH PRINCIPAL MERIDIAN,
TOWN OF ERIE, COUNTY OF WELD, STATE OF COLORADO
390.8797 ACRES
PD-001700-2024

WE ARE PROVIDING THIS EXAMPLE
OF HOW A DRIVE THROUGH FOR
A BANK HAS BEEN SUCCESSFULLY
INTEGRATED INTO THE PEDESTRIAN
COMMERCIAL MIXED-USE
ENVIRONMENT IN SOUTHERN LANDS
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NORTH WESTERLY

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Southern Land Company

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PCS GROUP, INC. 200 KALAMATH STREET, DENVER, CO - 80233 720-259-8246 CONTACT: JOHN PRESTWICH

REVISIONS:

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COMMERCIAL DEVELOPMENT STANDARDS

DRAWN BY:

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DESIGNED BY:

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SUBMITTED ON: 2/09/2023

A PARCEL OF LAND LOCATED IN SECTION 16, TOWNSHIP 1 NORTH, RANGE 68 WEST OF THE SIXTH PRINCIPAL MERIDIAN, TOWN OF ERIE, COUNTY OF WELD, STATE OF COLORADO 390.8797 ACRES PD-001700-2024

DEVELOPMENT STANDARDS

		DIM	1ENSIONAL ST	ANDARI	DS SUMN	1ARY TA	BLE			
	MINIMU STAND		MINI	MUM LOT	SETBACK	S (FT.)				
LOT TYPE	WIDTH (FT.)	AREA (S.F.)	FRONT ON STREET	FRONT ON GARDEN COURT] 3.5	SIDE (TO INTERIOR LOT)	REAR	HEIGHT	BUILDING SEPARATION	PORCH DEPTH CLEAR AREA
	45′		PRIN 10'				PRIN 15'		PRIN 10'	
SINGLE FAMILY FRONT LOAD		4,000	FRONT LOAD GAR. 20' SIDE LOAD GAR. 10'	NOT APPLICABLE	8′	5′				
	48' CORNER LOTS		ACC 25'				ACC 5'		ACC 5'	
SINGLE FAMILY	30′	0.000			01				PRIN 10'	
ALLEY LOAD	35' CORNER LOTS	- 2,600	8′	5′	8′	5′	Ο'		ACC 5'	
DUPLEX ALLEY	24′	1,700	8′	5′	8′	5′	0'	PRIN 35' ACC. 25'	PRIN 10'	6 FEET AS MEASURED FRO
LOAD	27' CORNER LOTS	1,700)		, o	3)		TAIN. 10	THE STUD WAL
TOWNHOME ALLEY	16′	1,000	8′	5′	8′	5′	Ο'		PRIN 10'	CENTERLINE O RAILING
LOAD	24' CORNER LOTS	1,000	0	3	o o	3)		TIXIIV. 10	
	16′	1000			O.	5 1			DDIN 10/	
LIVE WORK	24' CORNER LOTS	1,000	5′	5′	8′	5′	Ο'		PRIN 10'	
MULTI-FAMILY	200	1,000 PER DU	5′	5′	8′	5′	Ο'	PRIN 55' ACC. 25'	PRIN 10'	
COMMERCIAL	NONE	MAXIMUM FLOOR AREA RATIO - 1.0	5′	5′	8′	Ο'	Ο'	PRIN 60' ACC. 25'	PRIN 10'	NA
PLI			DEFE	R TO THE TOW	'N OF ERIE UNI	FIED DEVELOP	MENT CODE		1	

1. EASEMENTS MAY BE MORE RESTRICTIVE THAN MINIMUM SETBACKS, THE GREATER OF THE MINIMUM SETBACK	OR THE UTILITY EASEMENT SHALL GOVERN.
--	---------------------------------------

^{2.} EXCEPT FOR DETACHED ALLEY-LOADED GARAGES (WHICH MAY INCLUDE ADU'S), ACCESSORY STRUCTURES ARE NOT PERMITTED ON LOTS WHERE VEHICULAR ACCESS IS PROVIDED TO THE REAR OF THE LOT BY AN ALLEY.

LOT TYPE	PARKING REQUIREMENTS
SINGLE FAMILY FRONT LOAD	2 SPACES PER DU
SINGLE FAMILY ALLEY LOAD	2 SPACES PER DU
DUPLEX ALLEY LOAD	2 SPACES PER DU
TOWNHOME ALLEY LOAD	2 SPACES PER DU, +1 GUEST SPACE P 3 DU'S - ON-STREET PARKING FOR GUESTS IS ABLE TO BE COUNTED TOWARDS THE REQUIRED PARKING
LIVE WORK	2 SPACES PER DU, +1 GUEST SPACE P 3 DU'S - ON-STREET PARKING FOR GUESTS IS ABLE TO BE COUNTED TOWARDS THE REQUIRED PARKING
MULTI-FAMILY	1.25 SPACES PER EFFICIENCY, STUDIOR 1-BEDROOM DU; 2 SPACES PER DWITH 2 OR MORE BEDROOMS, PLUS GUEST SPACE PER 3 DU'S - ON-STREE PARKING FOR GUESTS IS ABLE TO BCOUNTED TOWARDS THE REQUIRED PARKING. TANDEM PARKING IS ABLE TO BE COUNTED TOWARDS MULTIFAMILY PARKING REQUIREMENTS.
COMMERCIAL USES	PER UDC (NOTE: WE ANTICIPATE UTILIZING SHARED PARKING PER TOWN OF ER UDC 10-6-6.E. PARKING ALTERNATIVE

ELECTRIC VEHICLE CHARGING SHALL BE PROVIDED PER BUILDING CODE WITH THE ADDITIONAL MINIMUM STANDARDS AS FOLLOWS. THE DEVELOPMENT SHALL INCLUDE A MIMIMUM OF 3 PUBLICLY ACCESSIBLE LEVEL 3 ELECTRIC VEHICLE ("EV") CHARGING STATIONS IN CONVENIENT LOCATIONS, AS APPROVED BY THE TOWN. IN ADDITION, AT LEAST 2% OF THE TOTAL PARKING SPACES FOR MULTI-FAMILY UNITS IN THE DEVELOPMENT SHALL BE EV CHARGING SPACES, AND AN ADDITIONAL 5% OF THE TOTAL PARKING SPACES FOR MULTI-FAMILY UNITS SHALL BE EV CHARGING READY SPACES.

ON-STREET PARKING SPACES IN THE RIGHT-OF-WAY ADJACENT TO THE PROPERTY MAY

BE COUNTED TO SATISFY THE MINIMUM OFF-STREET PARKING REQUIREMENTS.

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CONTACT: JIM HENRY

ENGINEERING:



LAND PLANNING:

Southern Land COMPANY 3990 HILLSBORO PIKE,

SUITE 400, NASHVILLE, TN 37215 615.778.2884 CONTACT: BEN CRENSHAW

PCS GROUP, INC. 200 KALAMATH STREET, DENVER, CO - 80233 720-259-8246 CONTACT: JOHN PRESTWICH

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SHEET INFO:

DEVELOPMENT STANDARDS

DRAWN BY: CGR **DESIGNED BY:** BC/SW

SUBMITTED ON: 2/09/2023


^{3.} CORNICES, EAVES, CHIMNEYS, BAY WINDOWS, ORNAMENTAL FEATURES, AND OTHER SIMILAR ARCHITECTURAL FEATURES MAY PROJECT UP TO TWO FEET INTO ANY REQUIRED SETBACK PROVIDED THESE PROJECTIONS ARE AT LEAST THREE FEET FROM THE LOT LINE.

^{4.} WINDOWS WELLS MAY ENCROACH UP TO THREE FEET INTO ANY REQUIRED SETBACK PROVIDED THEY ARE AT LEAST TWO FEET FROM THE LOT LINE.

^{5.} MAXIMUM HEIGHT IS MEASURED FROM BOTTOM OF STRUCTURE TO THE EAVE.

A PARCEL OF LAND LOCATED IN SECTION 16, TOWNSHIP 1 NORTH, RANGE 68 WEST OF THE SIXTH PRINCIPAL MERIDIAN,
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PD-001700-2024 |**TILITY CONCEPT PLΔN**|

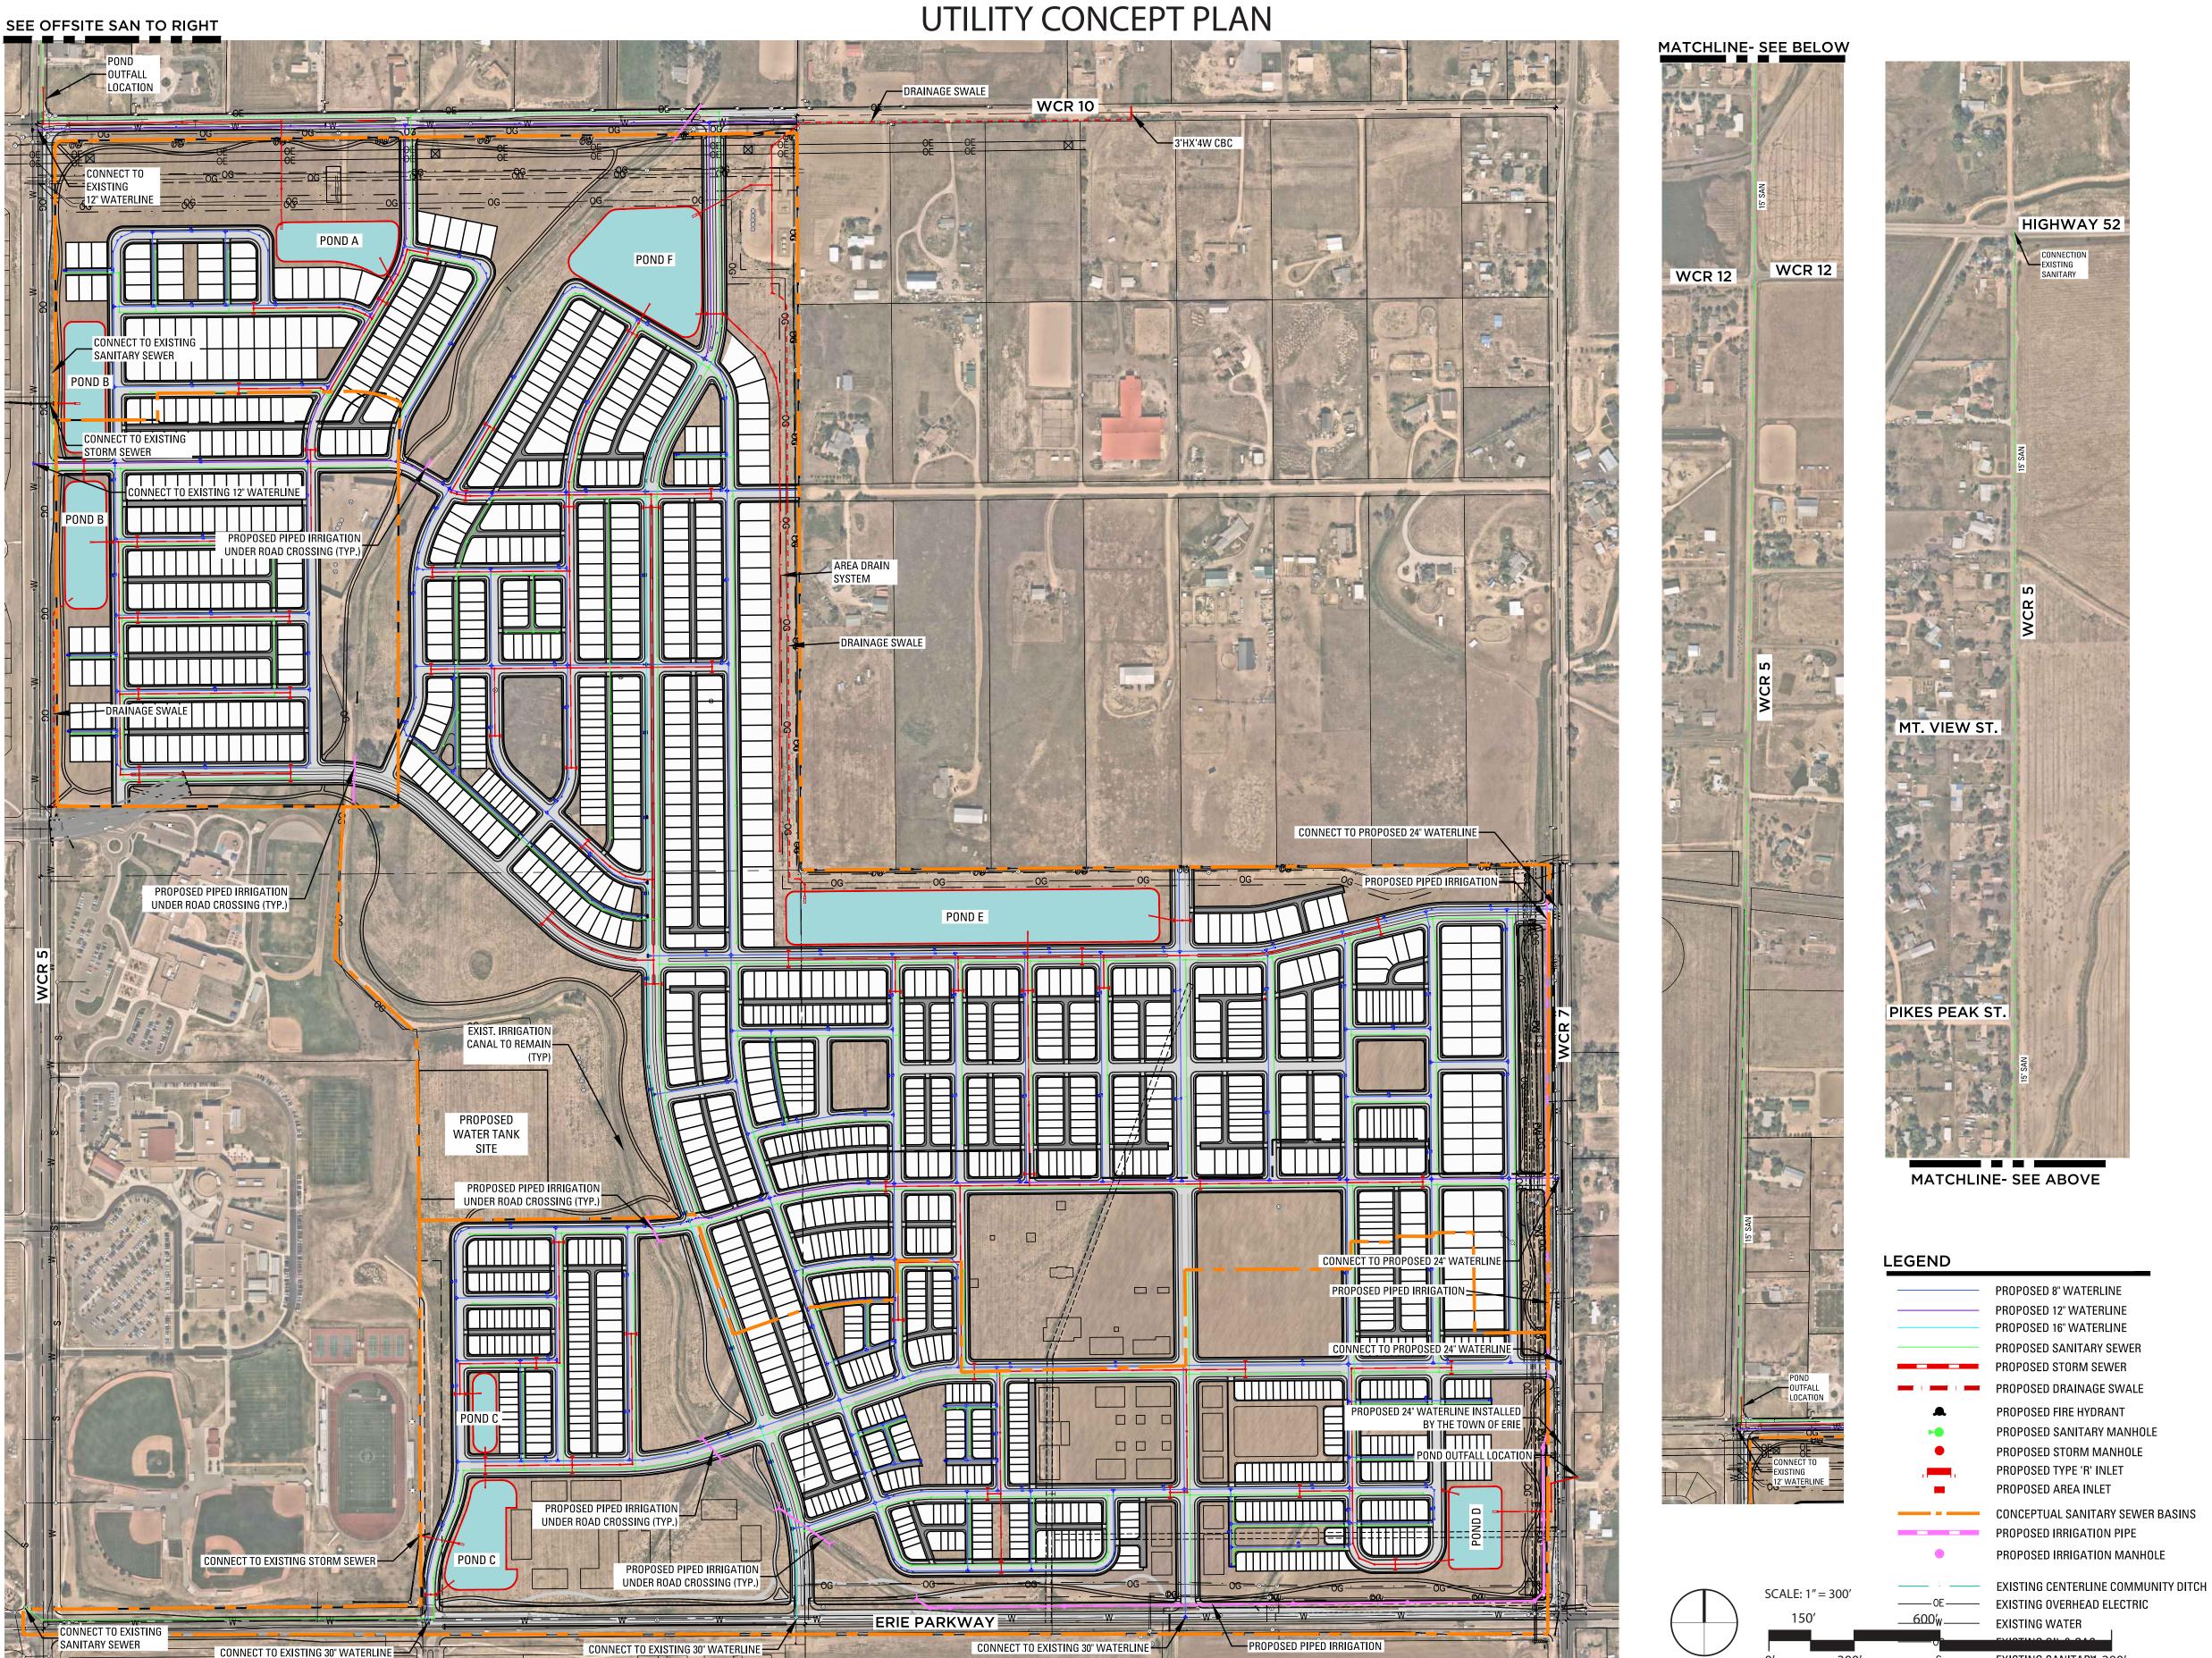

PREPARED FOR:

NORTH WESTERLY
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3990 HILLSBORO PIKE,
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JOHN PRESTWICH

 DATE
 BY

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 7/11/2024
 JP/CGR

 2
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 10/02/2024
 JP/CGR

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JTILITY CONCEPT PLAN

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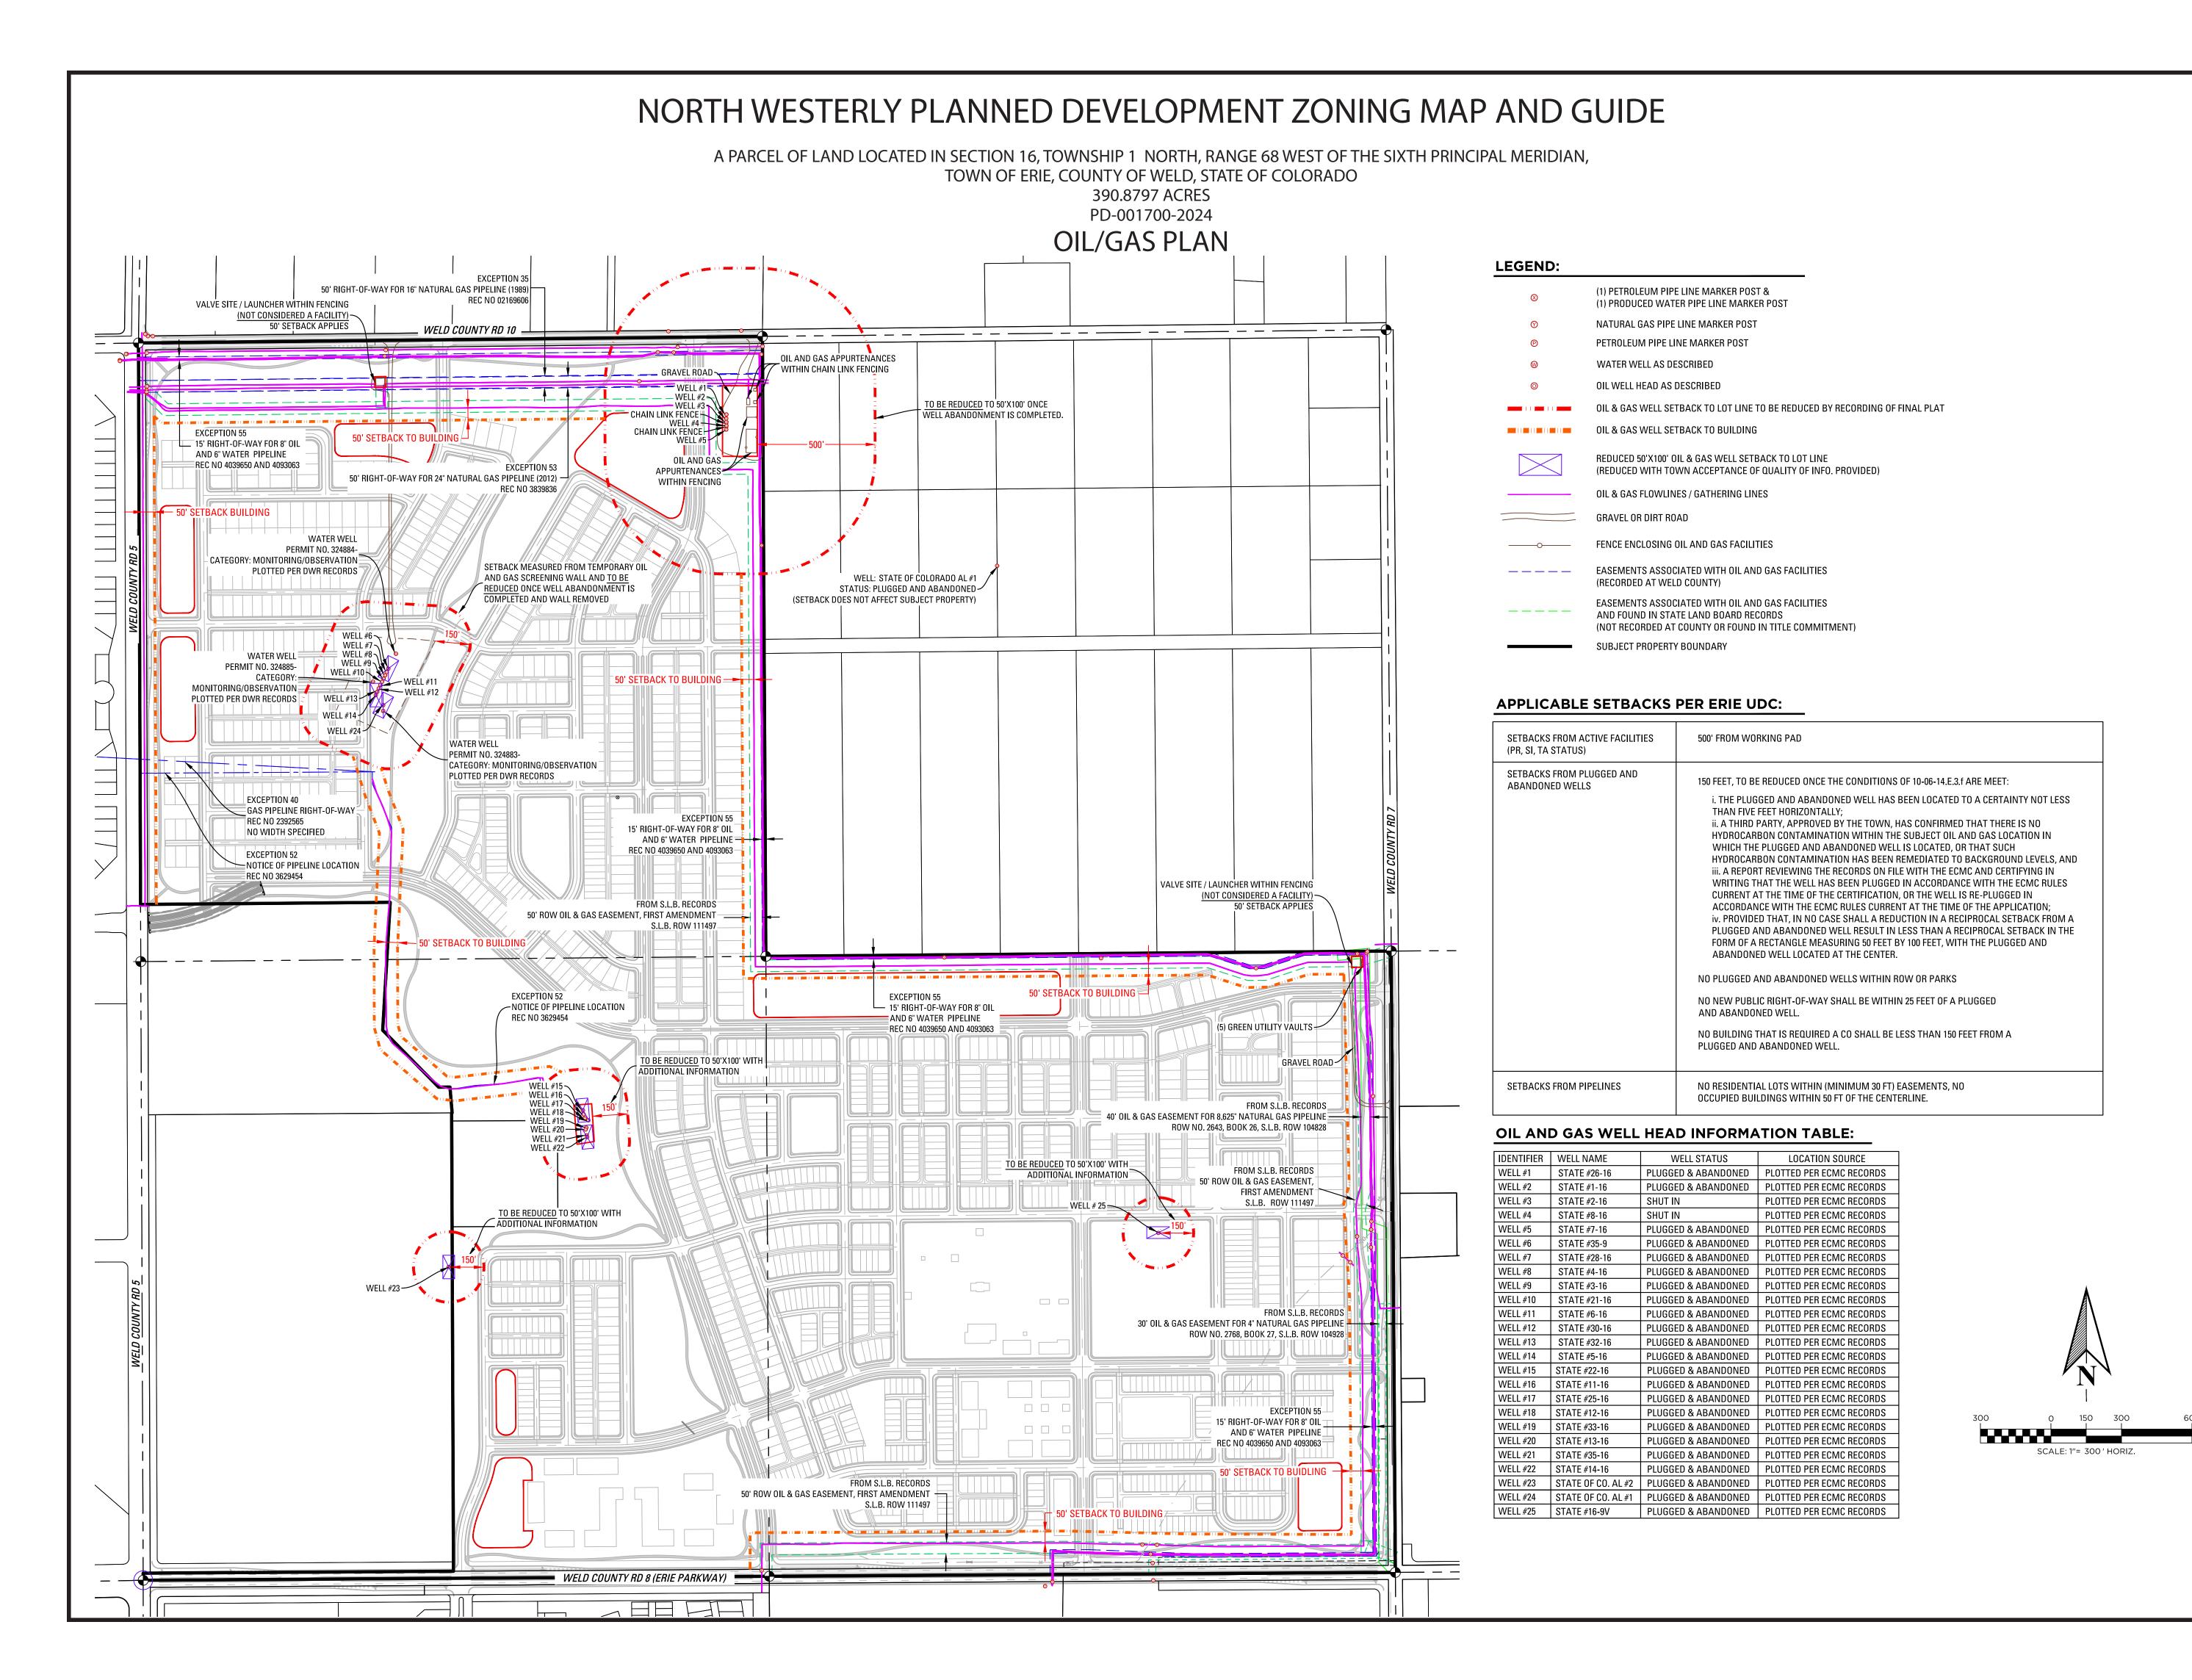
CGR

DESIGNED BY:

BC/SW

SUBMITTED ON: 2/09/2023





NORTH WESTERLY OWNER, LLC

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CONTACT:
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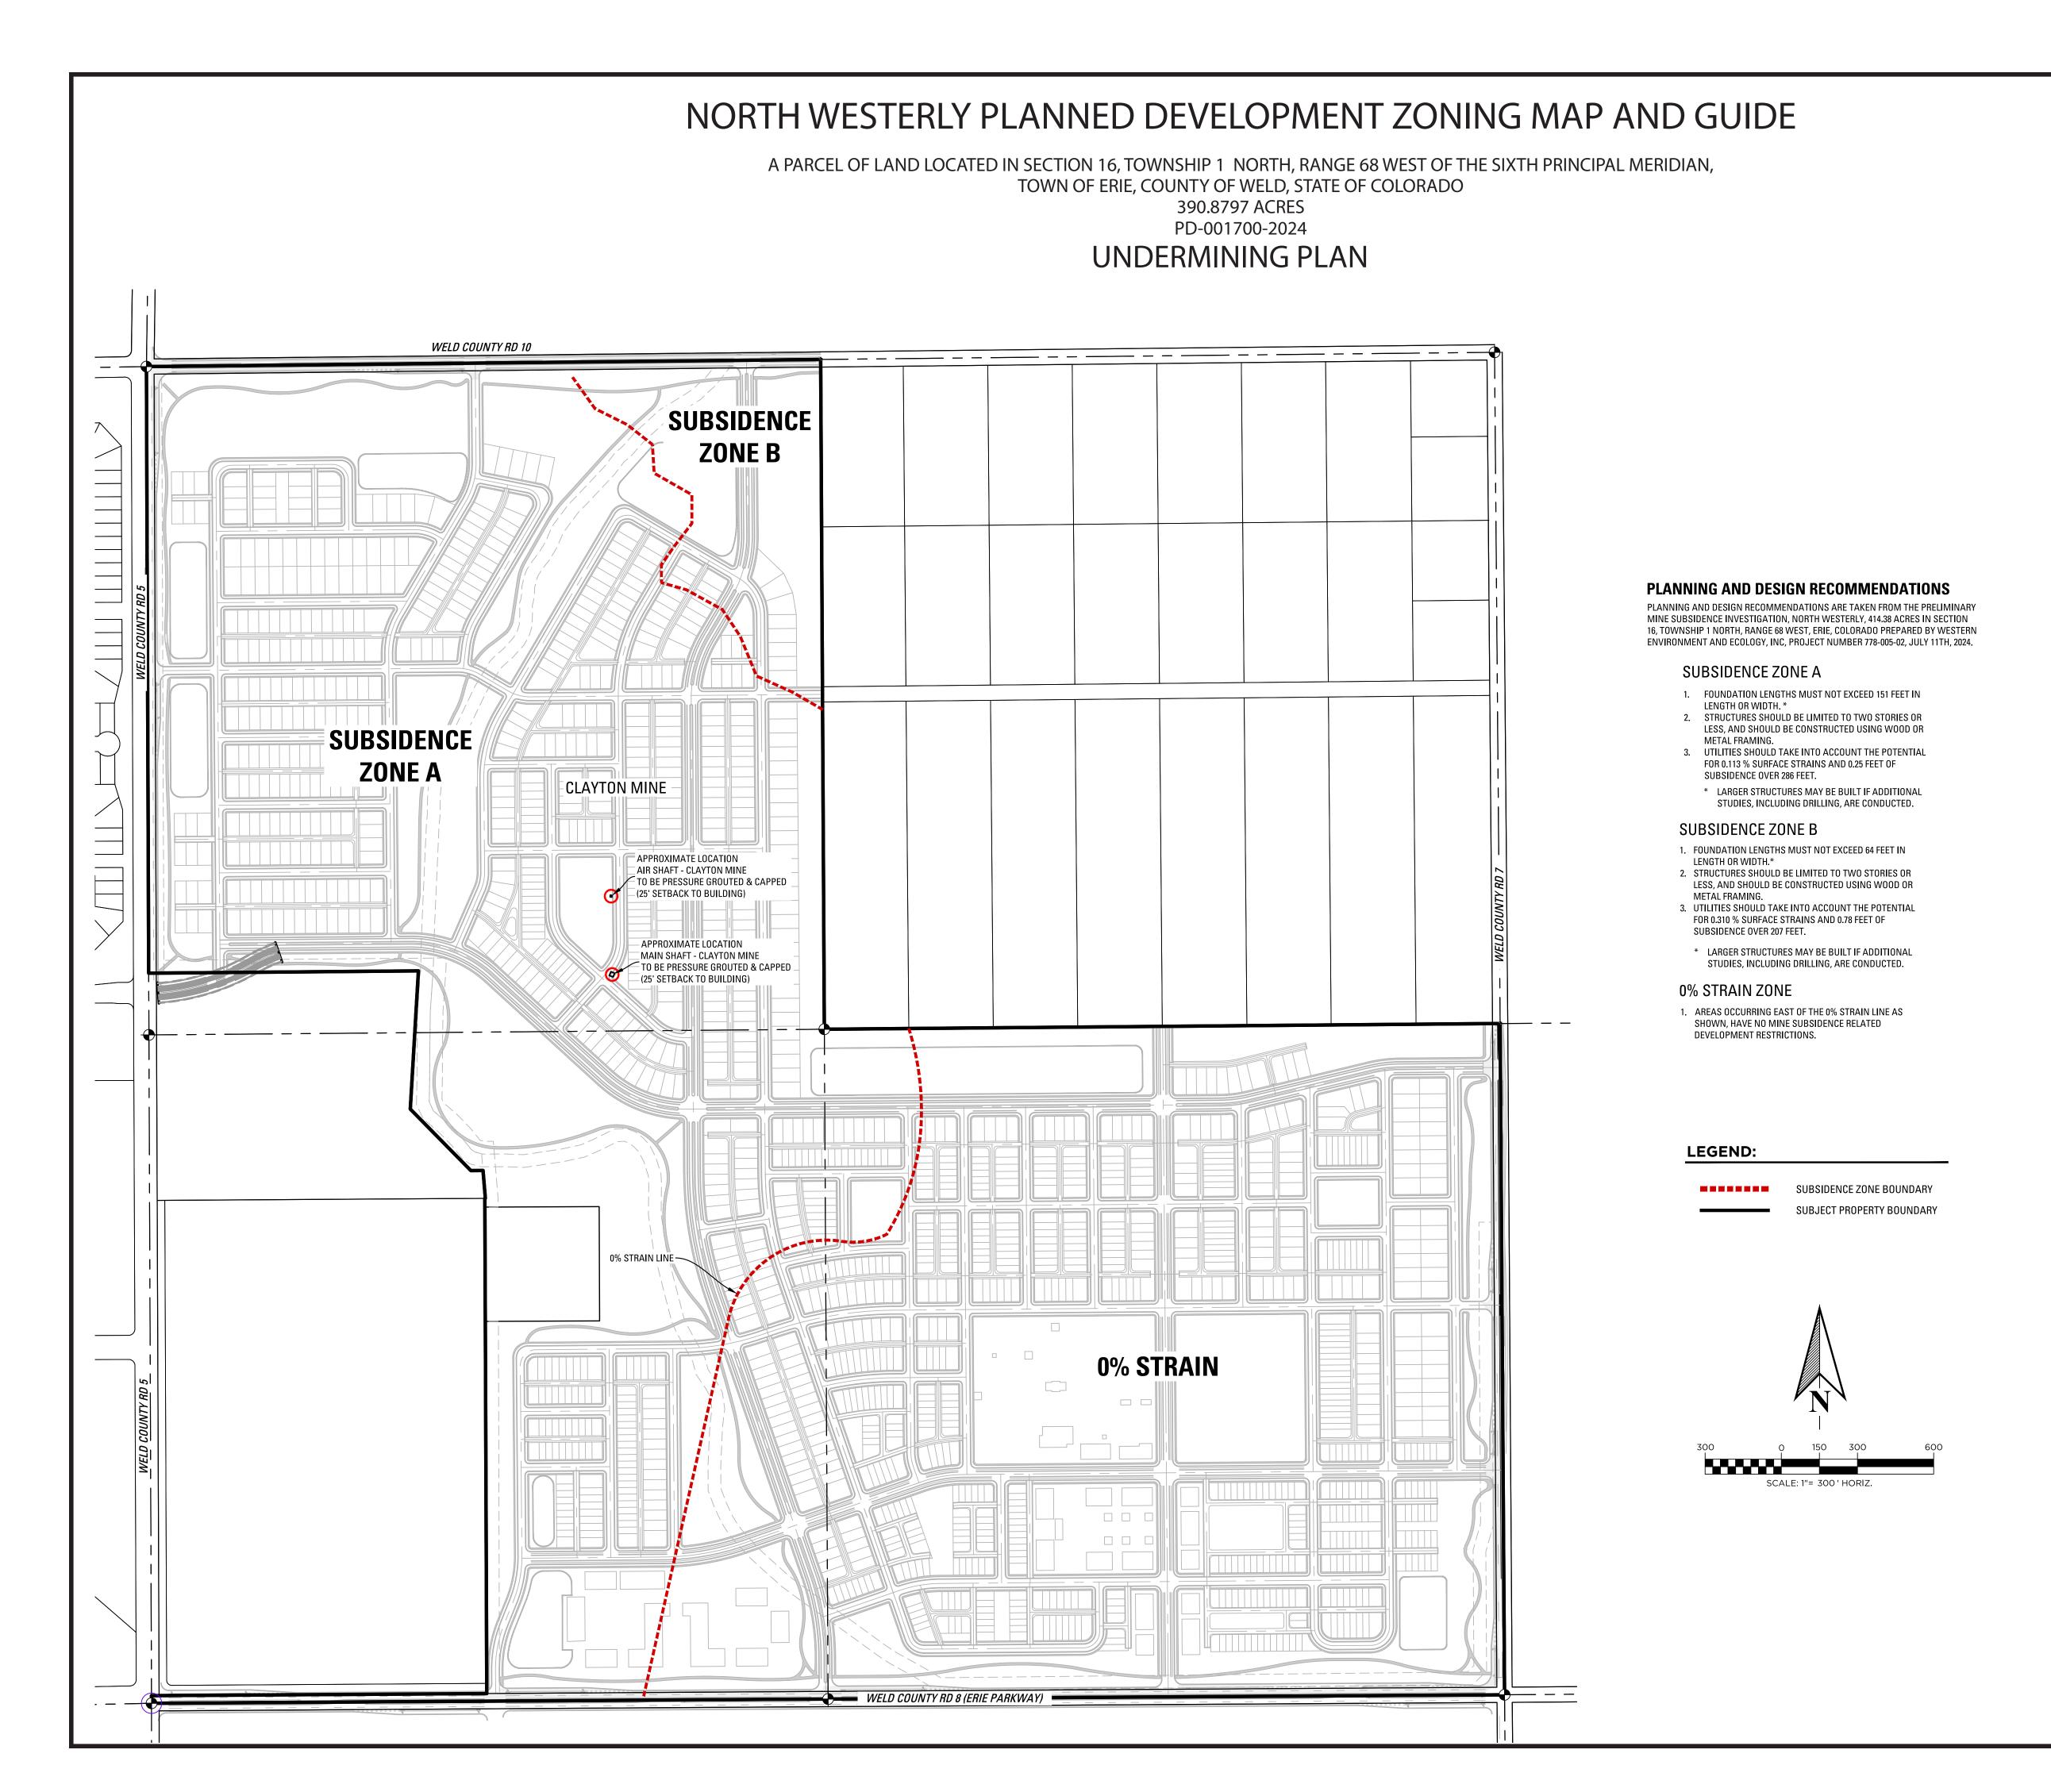
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PREPARED FOR:

OWNER, LLC

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PCS GROUP, INC. 200 KALAMATH STREET, DENVER, CO - 80233 720-259-8246 CONTACT: JOHN PRESTWICH

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UNDERMINING PLAN


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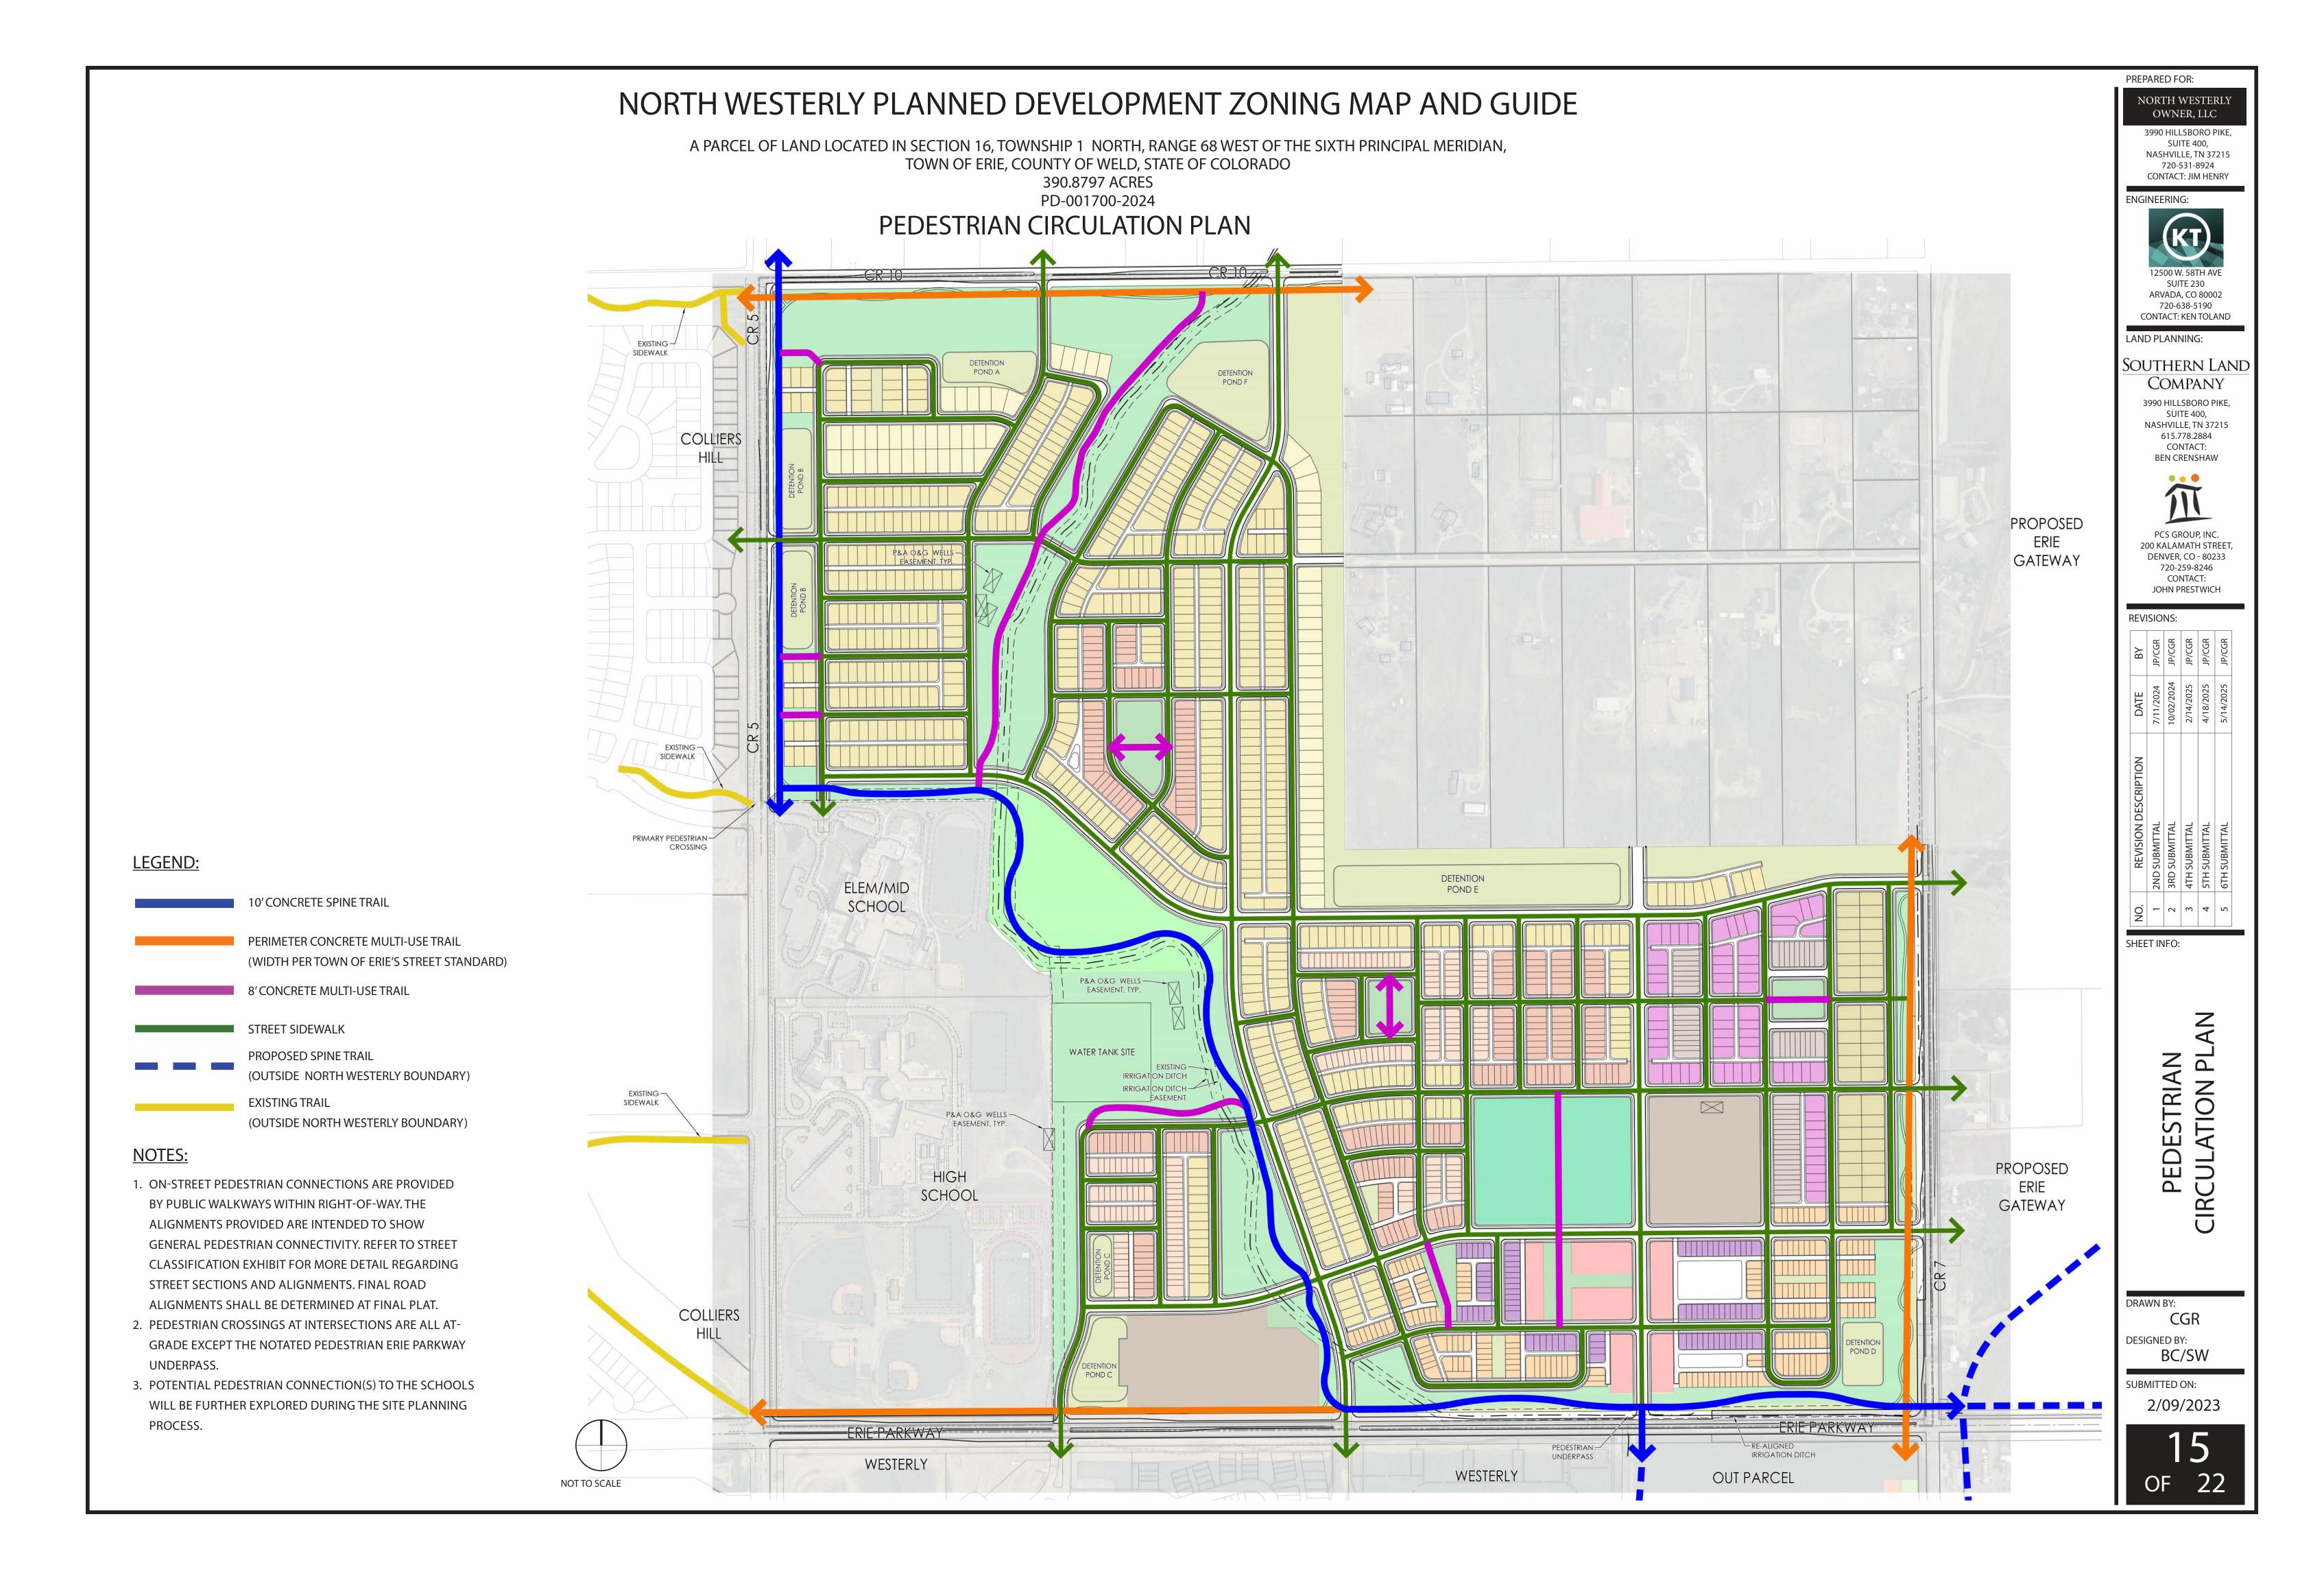
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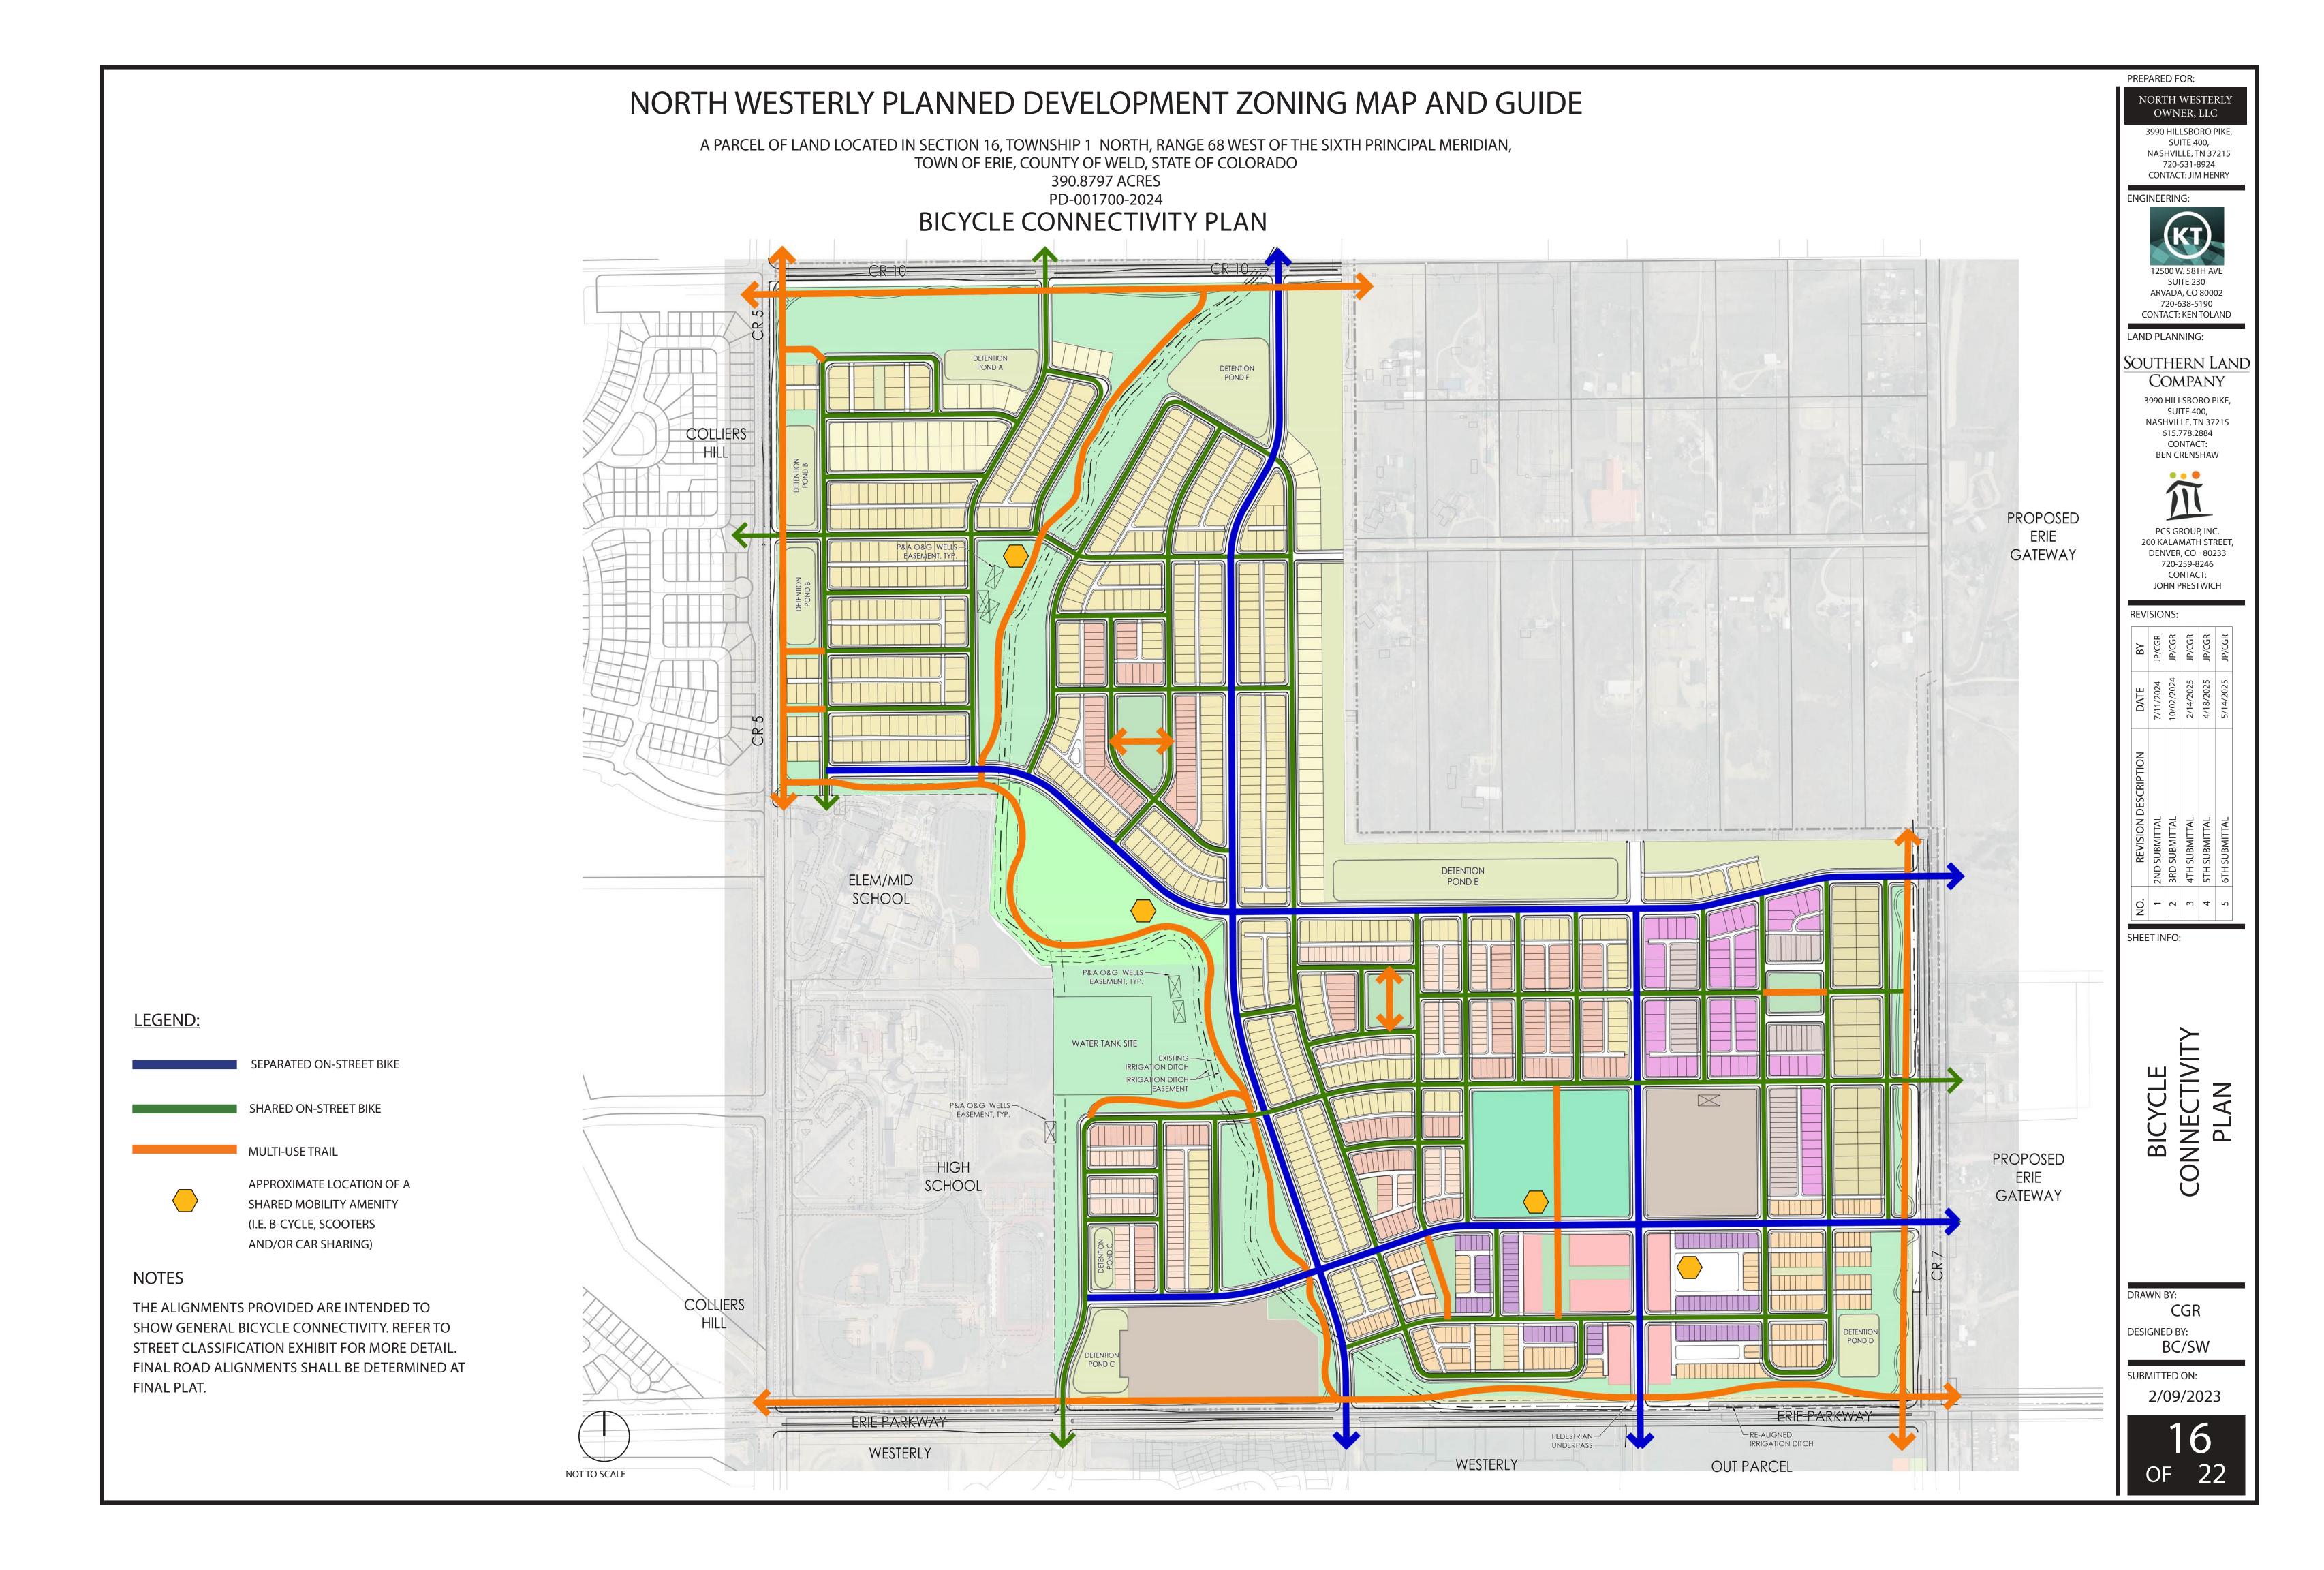
DESIGNED BY:

BC/SW

SUBMITTED ON: 2/09/2023





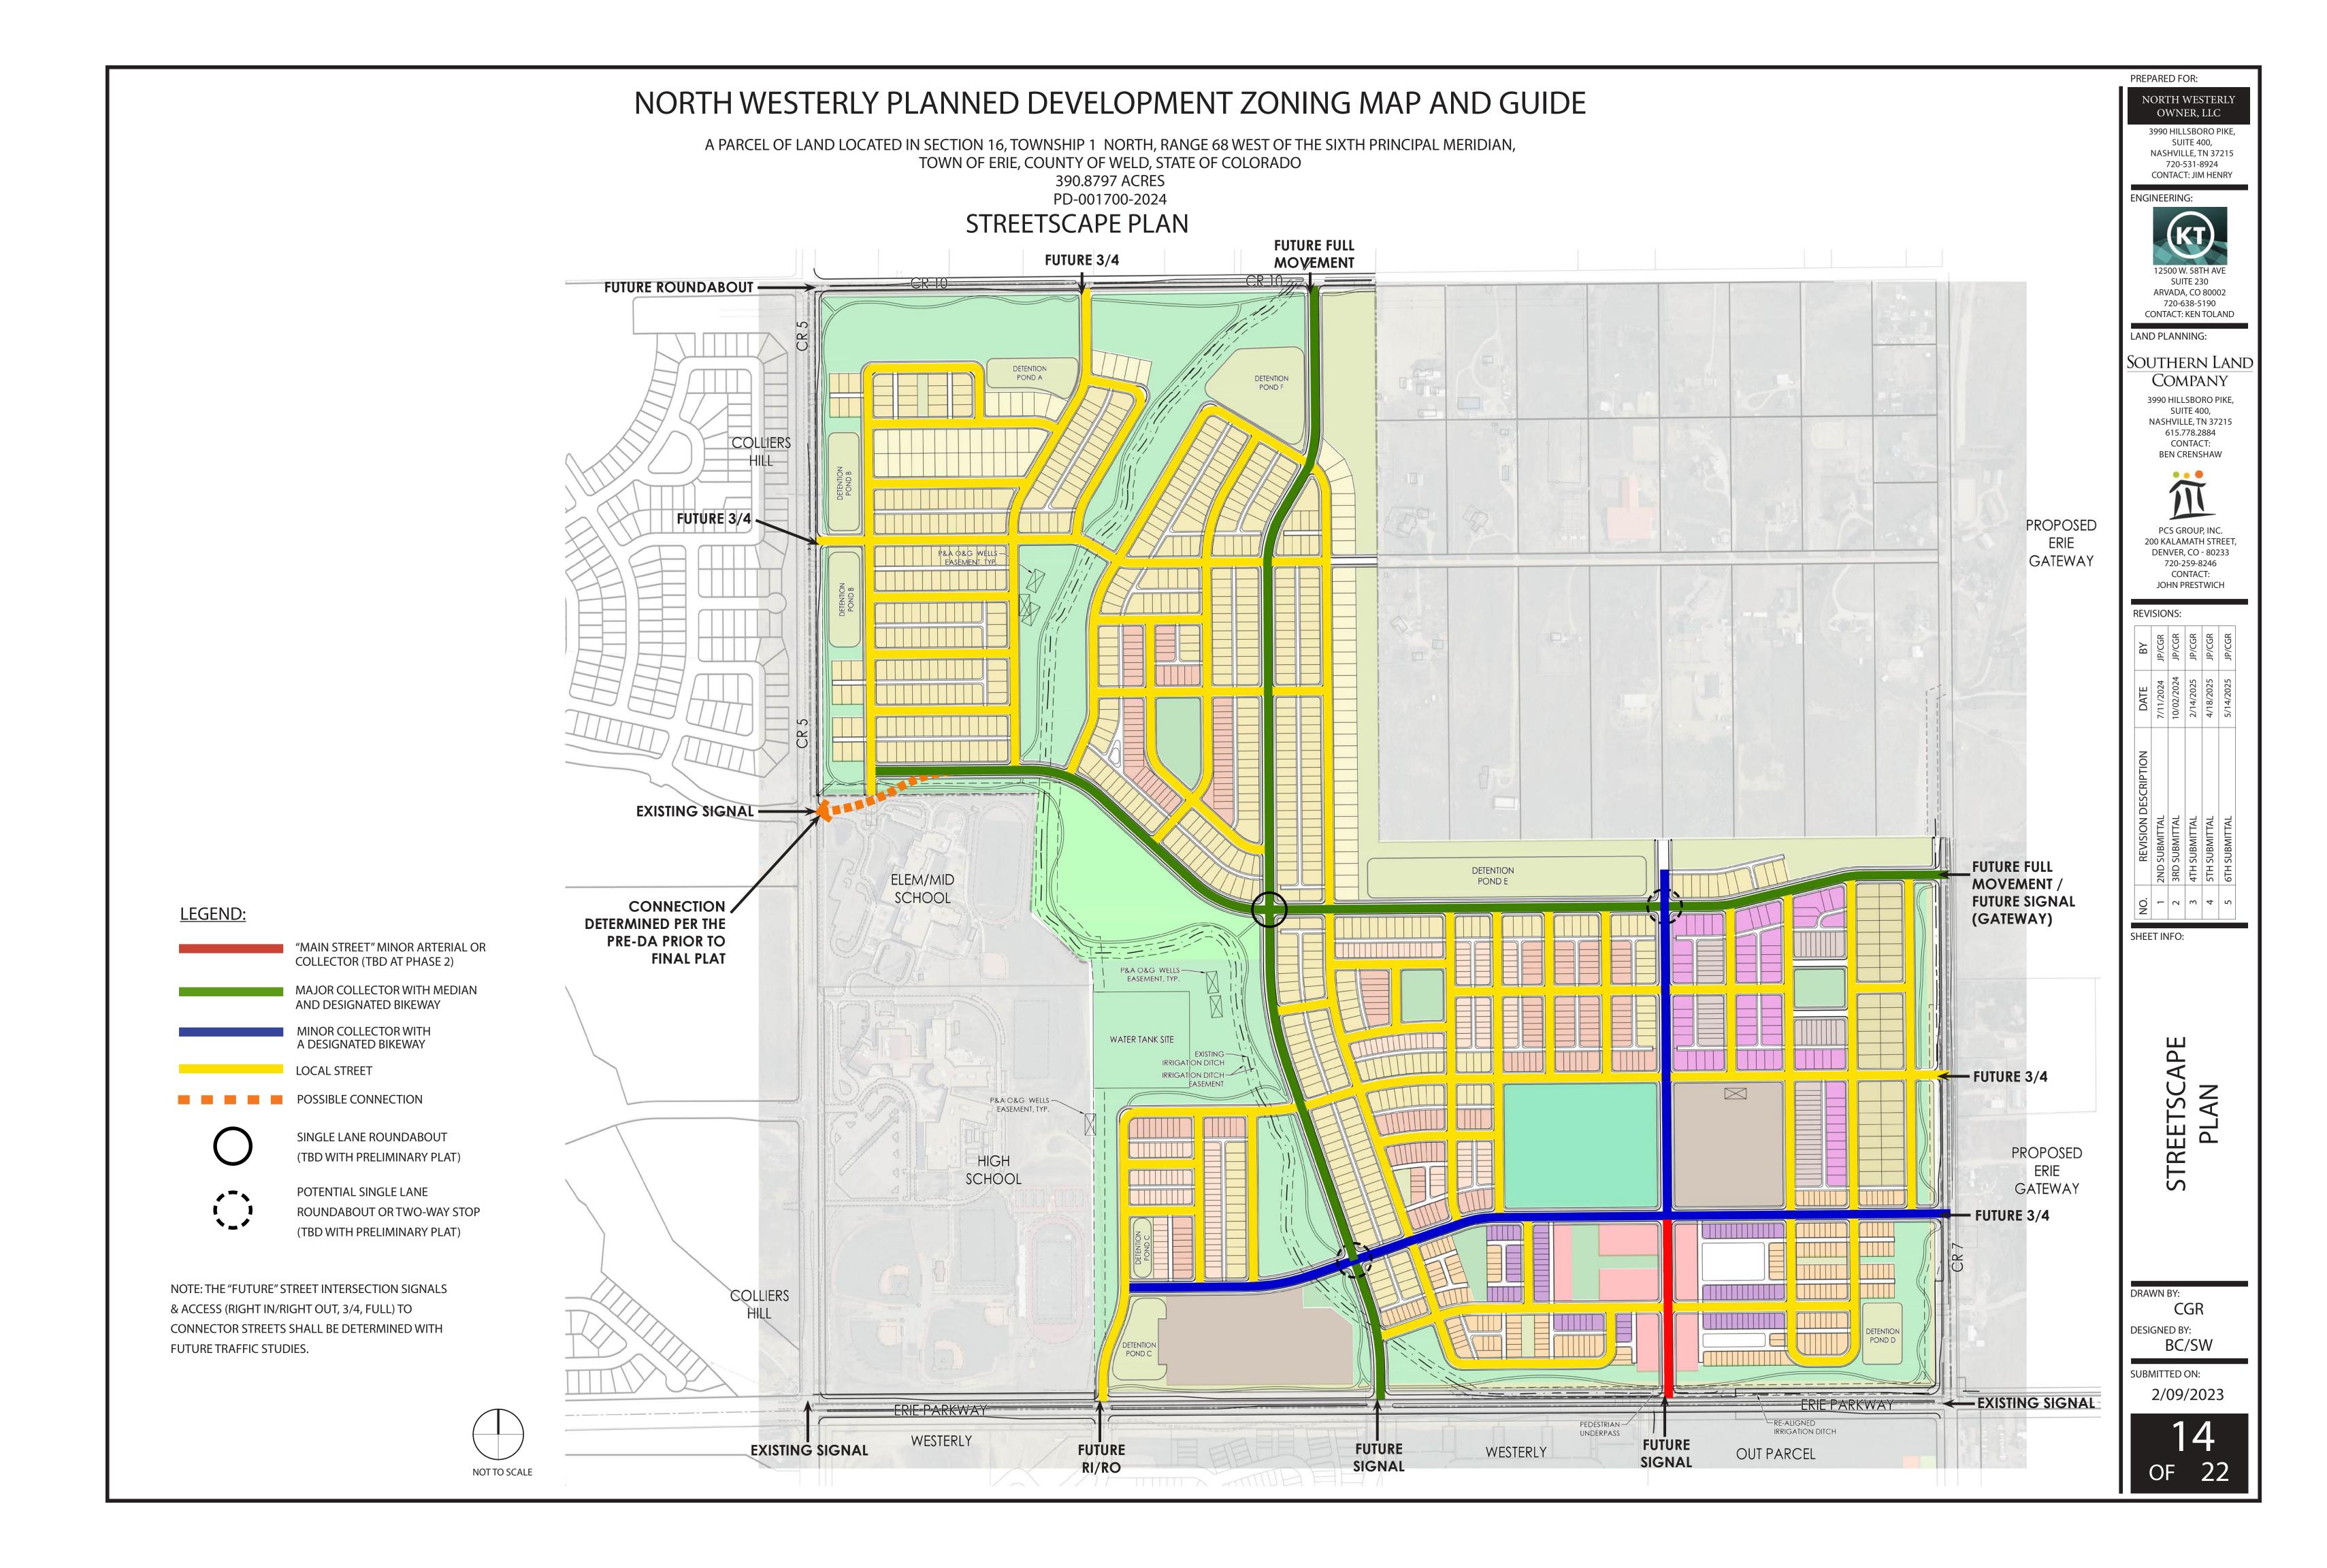


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390.8797 ACRES
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SIGNAGE PLAN

SIGNAGE PLAN:

- LIST OVERALL DESIGN INTENT
- THE OVERALL DESIGN INTENT FOR SIGNAGE IN THIS PEDESTRIAN ORIENTED COMMUNITY IS TO BE UNDERSTATED WITH HIGH QUALITY MATERIALS AND QUALITY EXECUTION AND DESIGN SIMPLICITY.
- PROVIDE MASTER SIGNAGE CHARACTERISTICS
- AT THIS EARLY STAGE IN THE DESIGN OF THE COMMUNITY WE ANTICIPATE PRIMARY ENTRY MONUMENTS ON ERIE PARKWAY, AND LIKELY SECONDARY MONUMENTS ON COUNTY ROAD 5 AND COUNTY ROAD 7, WITH THE POTENTIAL FOR RETAIL AND INTERNAL IDENTIFICATION SIGNAGE THROUGHOUT THE PROJECT THAT WILL BE OF A SIMILAR DESIGN CHARACTER. SIGNAGE WILL MEET UDC REQUIREMENTS 10-6-12.
- PROVIDE SIGN CHARACTERISTICS
 - BELOW ARE RENDERINGS OF SIGN CHARACTERISTICS DEVELOPED FOR THE WESTERLY COMMUNITY, WE ANTICIPATE USING A SIMILAR SIGN CHARACTERISTIC FOR NORTH WESTERLY SO THE COMMUNITY FEELS COHESIVE.

PRIMARY ENTRY MONUMENT

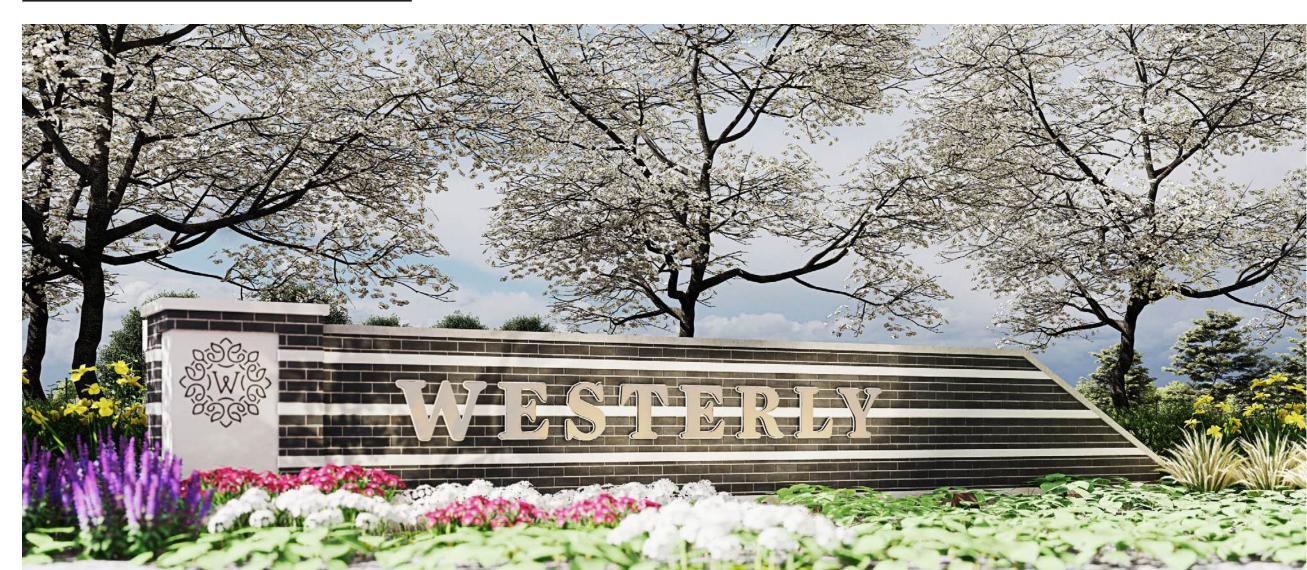

SECONDARY ENTRY MONUMENT



TRAIL MARKER



ANTICIPATED MONUMENT LOCATIONS

PRIMARY ENTRY MONUMENT

SECONDARY ENTRY MONUMENT



MONUMENT SIGNS LOCATED ALONG ERIE PARKWAY SHALL NOT BE LOCATED IN A LANDSCAPE TRACT OR AN EASEMENT WITHOUT PERMISSION OF THE

EASEMENT HOLDER.

PREPARED FOR:

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NORTH WESTERLY

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IGNAGE PLAN

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BC/SW


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OVERALL LIGHTING PLAN

OVERALL LIGHTING PLAN:

- PROVIDE OVERALL LIGHTING CONCEPT AND THEMES
- NORTH WESTERLY INTENDS TO FOLLOW THE TOWN OF ERIE UDC REQUIREMENTS FOR LIGHTING. IN GENERAL, LIGHTING THROUGHOUT THE COMMUNITY WILL UTILIZE PEDESTRIAN SCALED LIGHT FIXTURES IN PARK AREAS, AND POTENTIALLY BOLLARD STYLE LIGHTING IN THE COMMERCIAL MIXED USE AREAS.
- EXTERIOR BUILDING LIGHTING SHOULD BE USED TO PROVIDE SAFETY AND SECURITY AND TO HIGHLIGHT ARCHITECTURAL FEATURES.
- FOR COMMERCIAL AND MULTI-FAMILY BUILDINGS, ALL EXTERIOR DOORWAYS SHALL BE LIGHTED ALL NIGHT.
- FOR COMMERCIAL BUILDINGS, ALL LIGHT SOURCES SHALL BE SCREENED FROM VIEW OF ADJACENT PROPERTIES AND PUBLIC RIGHTS-OF-WAY. LIGHT POLES OF A MINIMUM HEIGHT TO PROVIDE ADEQUATE LIGHTING SHOULD BE USED. SEVERAL SHORT POLES ARE PREFERRED TO ONE TALLER POLE. LIGHT FROM COMMERCIAL DEVELOPMENTS MAY NOT SPILL ONTO RESIDENTIAL SITES. NOT MORE THAN 1-FOOT CANDLE FROM COMMERCIAL DEVELOPMENTS SHALL BE PERMITTED LEAVE THE PROPERTY/SITE. A PLAN TO REDUCE UNNECESSARY LIGHTING AFTER BUSINESS HOURS SHALL BE PROVIDED.
- ESTABLISH FIXTURE STYLES
 - BELOW ARE SOME POTENTIAL PEDESTRIAN AND BOLLARD LIGHTS THAT DEPICT THE DESIGN AND QUALITY INTENT FOR NORTH WESTERLY, THE PEDESTRIAN LIGHT DEPICTED IS THE SAME AS IS CURRENTLY USED IN THE WESTERLY COMMUNITY. STREET LIGHT FIXTURES WILL ALSO BE THE SAME AS ARE CURRENTLY USED IN THE WESTERLY COMMUNITY AND ARE COMPLIANT WITH THE TOWN OF ERIE UDC.
- LED LIGHTS ARE REQUIRED FOR ANY TOWN OWNED OR MAINTAINED LIGHT POLES



PEDESTRIAN LIGHT

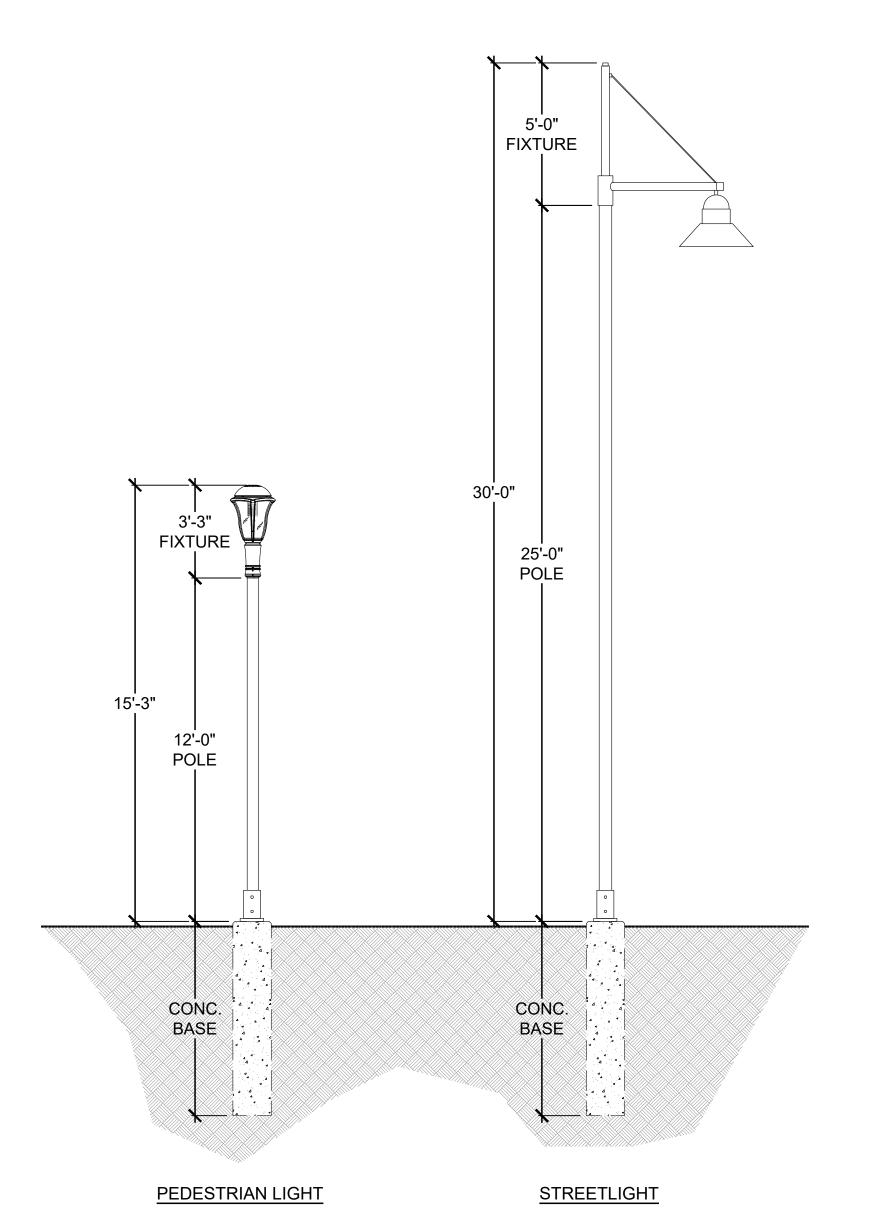MANUFACTURER: LUMEC BY SIGNIFY
PRODUCT: CLASSIC STYLE VLR POST TOP
MODEL#: VLR-CAGE

<u>STREETLIGHT</u>

UNITED POWER STANDARD

PRODUCT: 25' LIGHTPOLE WITH 150W MH
LUMINAIRE AND ARM

MODEL#M26-150C

SCALE: 1/4" = 1'-0" 2' 8' 0' 4' 16'

PEDESTRIAN AND BOLLARD LIGHTING









PREPARED FOR:

OWNER, LLC 3990 HILLSBORO PIKE, SUITE 400,

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SHEET INF

OVERALL
IGHTING PLAN

DRAWN BY:

CGR

DESIGNED BY:

BC/SW

SUBMITTED ON: 2/09/2023

A PARCEL OF LAND LOCATED IN SECTION 16, TOWNSHIP 1 NORTH, RANGE 68 WEST OF THE SIXTH PRINCIPAL MERIDIAN, TOWN OF ERIE, COUNTY OF WELD, STATE OF COLORADO 390.8797 ACRES PD-001700-2024

PARKS & OPEN SPACE CONCEPT

INTENT & CHARACTER:

NORTH WESTERLY PARKS AND OPEN SPACE CONCEPT NARRATIVE

THE PD MEETS THE UDC BY COMPLYING WITH PARK LAND DEDICATION REQUIREMENTS AND INCLUDING A DIVERSITY OF TYPES OF PARKS, TRAILS, AND OPEN SPACE WHICH CAN BE OUTLINED IN THE PARKS AND OPEN SPACE CHART. THE PARKS AND OPEN SPACE CHART OUTLINES HOW EACH AREA IS CATEGORIZED BY THE CRITERIA SET FORTH IN THE "MIXED-USE DEVELOPMENT PARKS & OPEN SPACE VISION GUIDE". THE DEVELOPMENT WILL INCLUDE SEVERAL TRADITIONALLY SIZED POCKET PARKS AND A LARGE NEIGHBORHOOD PARK. THE BIGGEST TYPOLOGY FOR OPEN SPACE WILL BE THE MIXED-USE OPEN SPACE, AS TRAIL CORRIDORS, MEDIAN PARKS WITH POCKET PARK ELEMENTS AND NATIVE URBAN REWILDING AREAS, AND AMENITIZED DRAINAGEWAYS. BELOW ARE SOME HIGHLIGHTED FEATURES THAT REPRESENT THE DIFFERENT TYPES OF OPEN SPACE AND PARK FEATURES THROUGHOUT THE SITE:

- THE DEVELOPMENT WILL TAKE ADVANTAGE OF OPEN SPACES FOR RESPITE, RECREATION AND PEDESTRIAN CONNECTIONS. THEY SHALL CONTAIN PEDESTRIAN-SCALE OR MULTI-USE TRAILS, BENCHES, PLANTINGS, AND WHERE APPROPRIATE SHADE SHELTERS, INTERPRETATIVE GARDENS, SMALL PLAY FEATURES OR WATER FEATURES.
- THE POCKET PARKS SHALL INCORPORATE SPECIFIC TYPES OF PLAY AREAS, COMMUNITY GARDENS, AND/OR ART FEATURES TO CREATE VARIETY THROUGHOUT THE COMMUNITY AND BECOME UNIQUE PLACEMAKERS FOR EACH NEIGHBORHOOD.
- APPROXIMATELY A 15 AC NEIGHBORHOOD PARK (TO BE DEDICATED TO THE TOWN?) WILL SERVE AS THE CENTRAL FEATURE OF THE COMMUNITY. IT IS ENVISIONED TO BE THE RECREATIONAL HEART OF THE COMMUNITY. NOT ONLY WILL IT CONTAIN PLAYGROUNDS, TRAILS, AND SPORTS FIELDS, BUT IT SHALL ALSO SERVE AS THE PLACE FOR SPECIAL COMMUNITY EVENTS, SUCH AS LIVE MUSIC, COMPETITIONS, AND HOLIDAY FESTIVALS TO CREATE A SENSE OF PLACE AND COMMUNITY.
- THE TOWN HAS ALSO REQUESTED THAT THE PD INCLUDE AN AREA FOR A WATER TANK (APPROXIMATELY 4.9 ACRES) WHICH CAN BE COUNTED TOWARD 100% OF PARK SPACE. THIS AREA HAS BEEN INCORPORATED INTO THE LARGE NEIGHBORHOOD PARK.
- THE DETENTION PONDS WILL ALSO PLAY A KEY ROLE AS FEATURES FOR THE DEVELOPMENT, AS A NATURAL POND WITH SEATING, PICNIC AREAS, AND TRAILS.
- AS PART OF THE PRE-DEVELOPMENT AGREEMENT, "THE DEVELOPMENT SHALL PROVIDE COMMUNITY GARDENS, EDIBLE LANDSCAPING, OR ON-SITE URBAN AGRICULTURE ACCESSIBLE TO ALL THE RESIDENTS OF THE DEVELOPMENT, TO BE SERVED BY POTABLE WATER. EDIBLE LANDSCAPING IS THE PRACTICE OF FULL INTEGRATING A VARIETY OF EDIBLE PLANTS INTO ORNAMENTAL LANDSCAPES. COMMUNITY GARDENS SHALL NOT COUNT TOWARD POCKET PARK REQUIREMENTS AND SHALL NOT BE OWNED OR MAINTAINED BY THE TOWN." THE DESIGN AND IMPLEMENTATION OF THE COMMUNITY GARDENS, EDIBLE LANDSCAPES OR URBAN AGRICULTURE WILL BE MORE FULLY DEVELOPED AT DESIGN DEVELOPMENT STAGES.

AS PART OF THE PEDESTRIAN CONNECTIVITY PLAN, THERE WILL BE THREE MAJOR TRAIL SYSTEMS THAT ARE PART OF THE OPEN SPACE PLAN.

- THE SPINE TRAIL THAT RUNS WITHIN THE LOWER PORTION OF THE SITE FROM THE ADJACENT HIGH SCHOOL TO THE SOUTHWEST INTERSECTION.
- THE MULTI-USE TRAIL ALONG THE IRRIGATION DITCH WHICH WILL BE AMENITIZED FEATURE AS IT MEANDERS THROUGH THE SITE FROM THE NORTH PART OF THE SITE TO CONNECT INTO THE SPINE TRAIL.
- LASTLY, PERIMETER TRAILS THAT ARE WITHIN THE BUFFER AREAS ALONG CR7, CR10, CR5, AND ERIE



ABOVE IMAGES: OPEN SPACES SHALL HAVE PEDESTRIAN CONNECTIONS ALONG WITH PLACES FOR RESPITE.





ABOVE IMAGES: SITE FURNISHINGS SUCH AS BENCHES, PICNIC TABLES, AND SHADE SHELTERS SHALL BE USED FOR PEDESTRIAN COMFORTABILITY.

PREPARED FOR:

OWNER, LLC

3990 HILLSBORO PIKE, SUITE 400, NASHVILLE, TN 37215 720-531-8924 CONTACT: JIM HENRY

ENGINEERING:



LAND PLANNING:

SOUTHERN LAND COMPANY

3990 HILLSBORO PIKE, SUITE 400, NASHVILLE, TN 37215 615.778.2884 CONTACT:




200 KALAMATH STREET DENVER, CO - 80233 720-259-8246 CONTACT: JOHN PRESTWICH


REVISIONS:

ı	ВУ	JP/CGR	JP/CGR	JP/CGR	JP/CGR	JP/CGR	
	DATE	7/11/2024	10/02/2024	2/14/2025	4/18/2025	5/14/2025	
	REVISION DESCRIPTION	2ND SUBMITTAL	3RD SUBMITTAL	4TH SUBMITTAL	5TH SUBMITTAL	6TH SUBMITTAL	
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DRAWN BY: **DESIGNED BY:** BC/SW

SUBMITTED ON: 2/09/2023



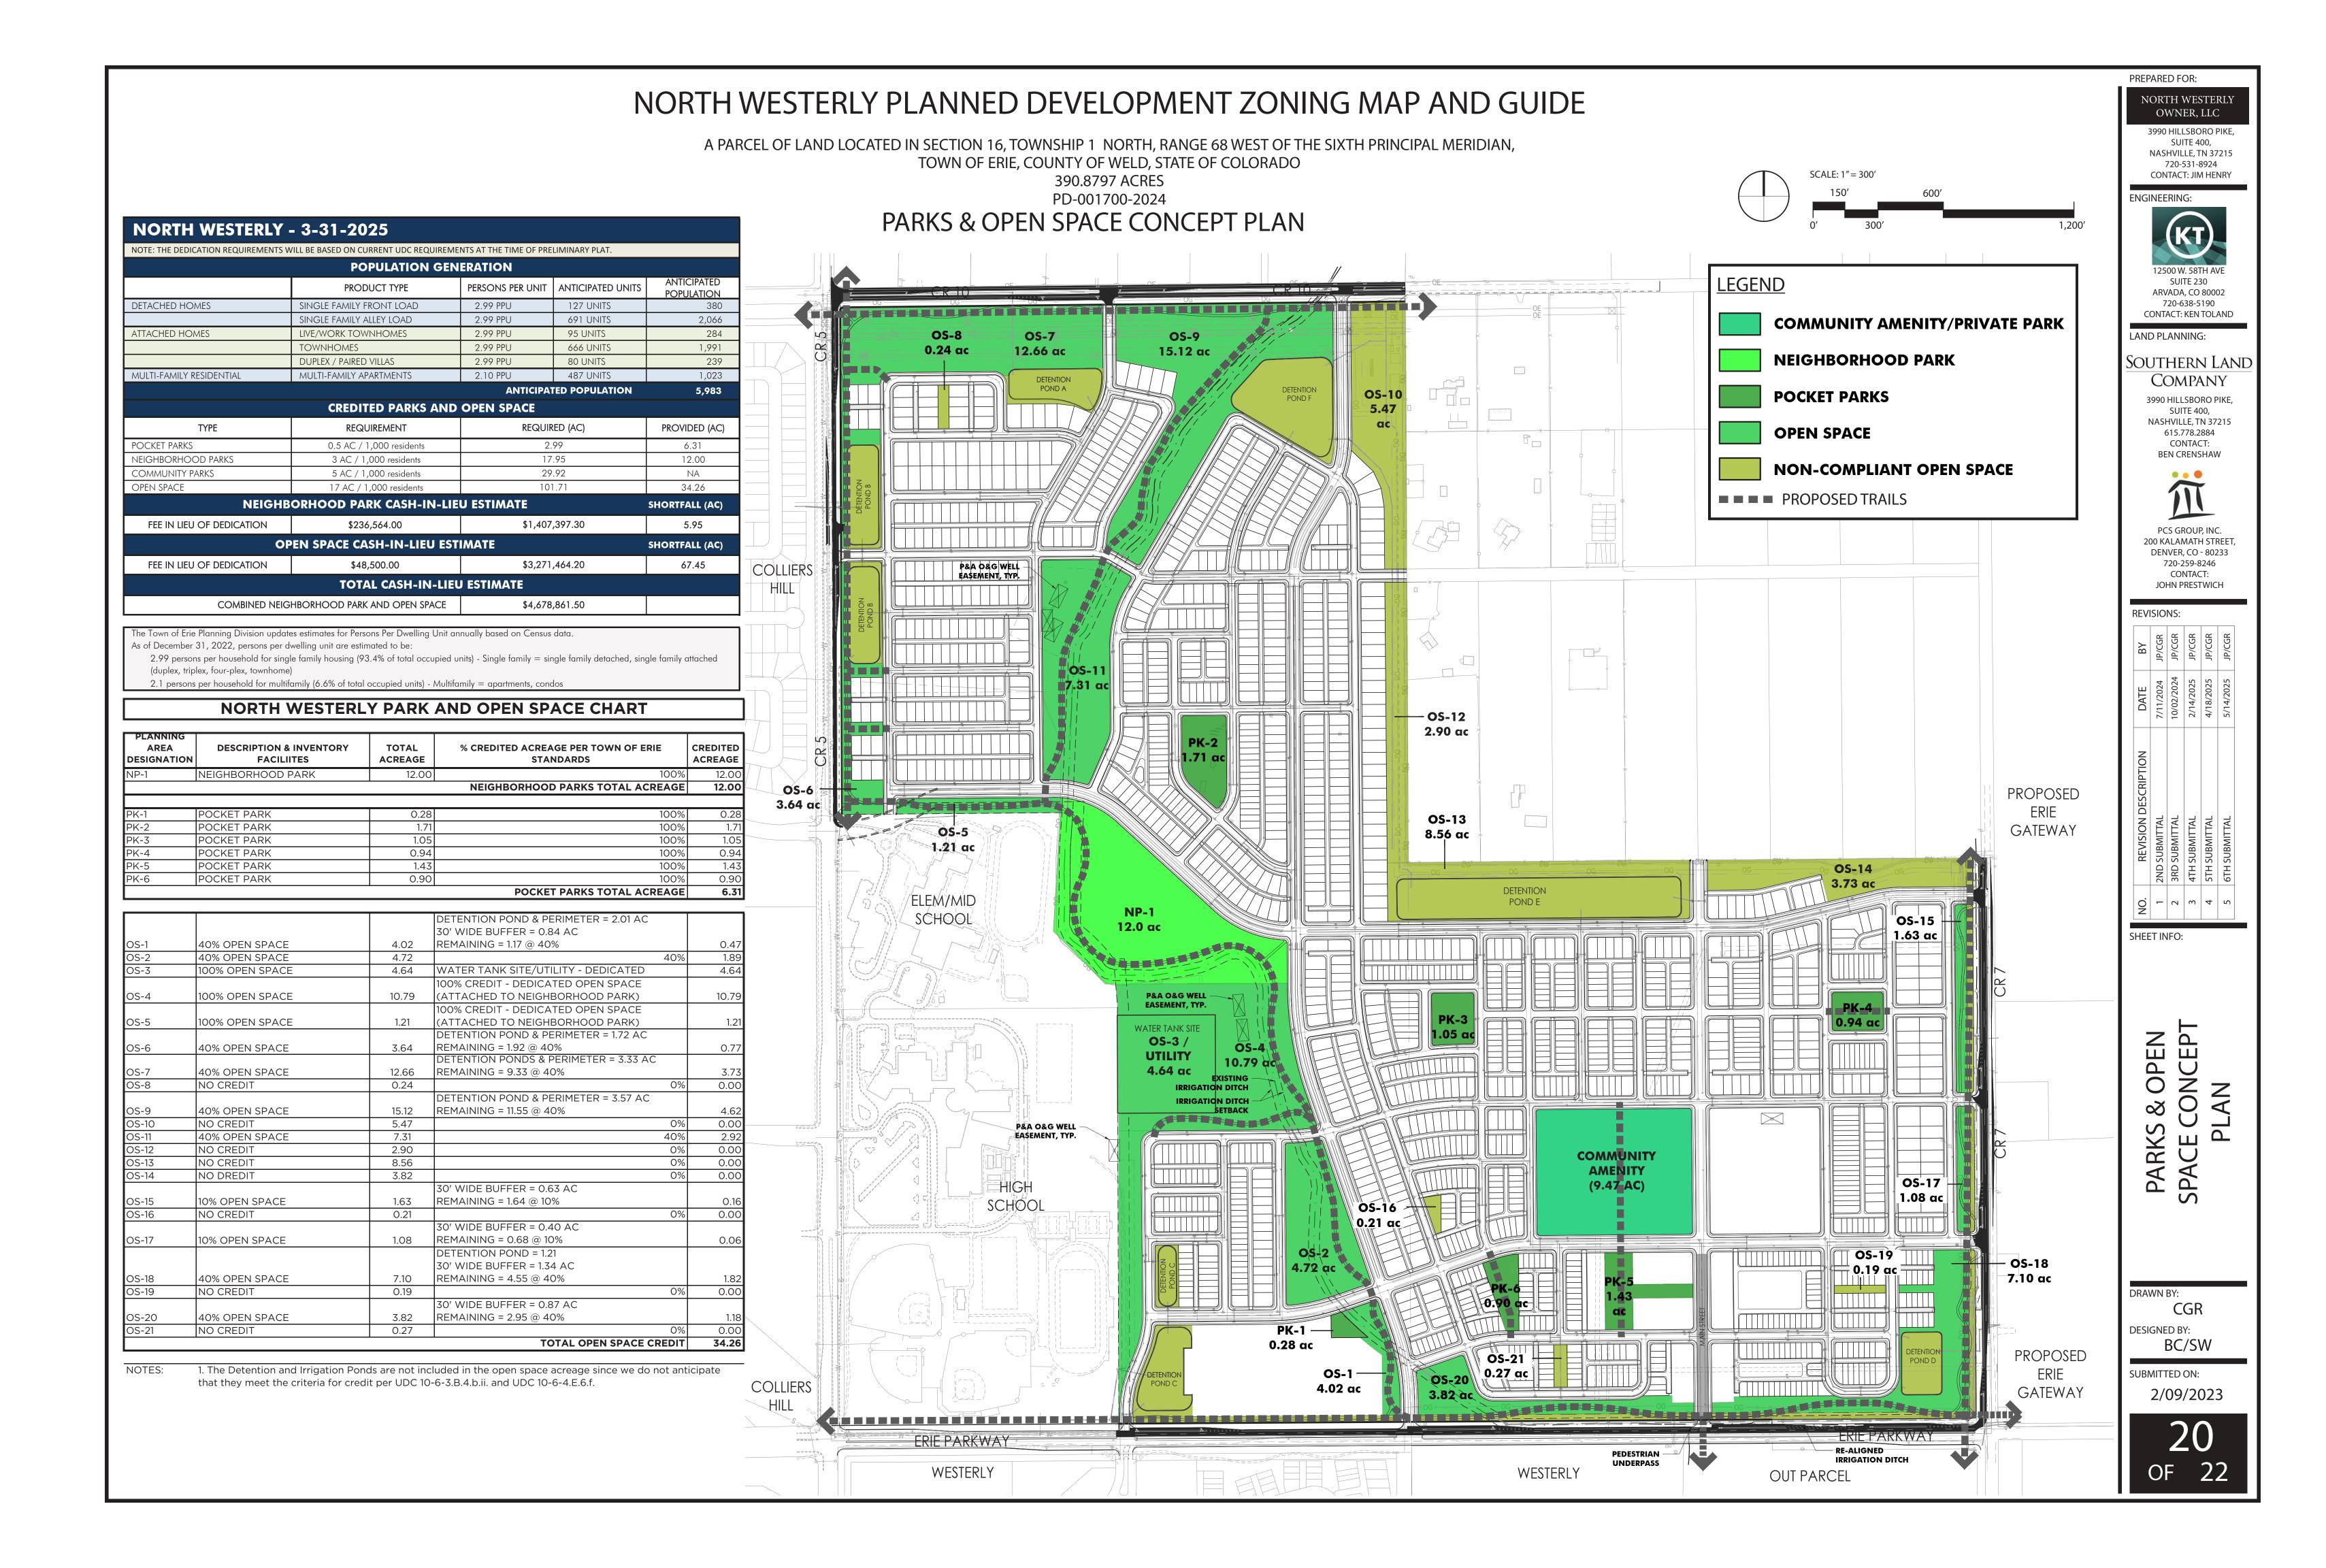

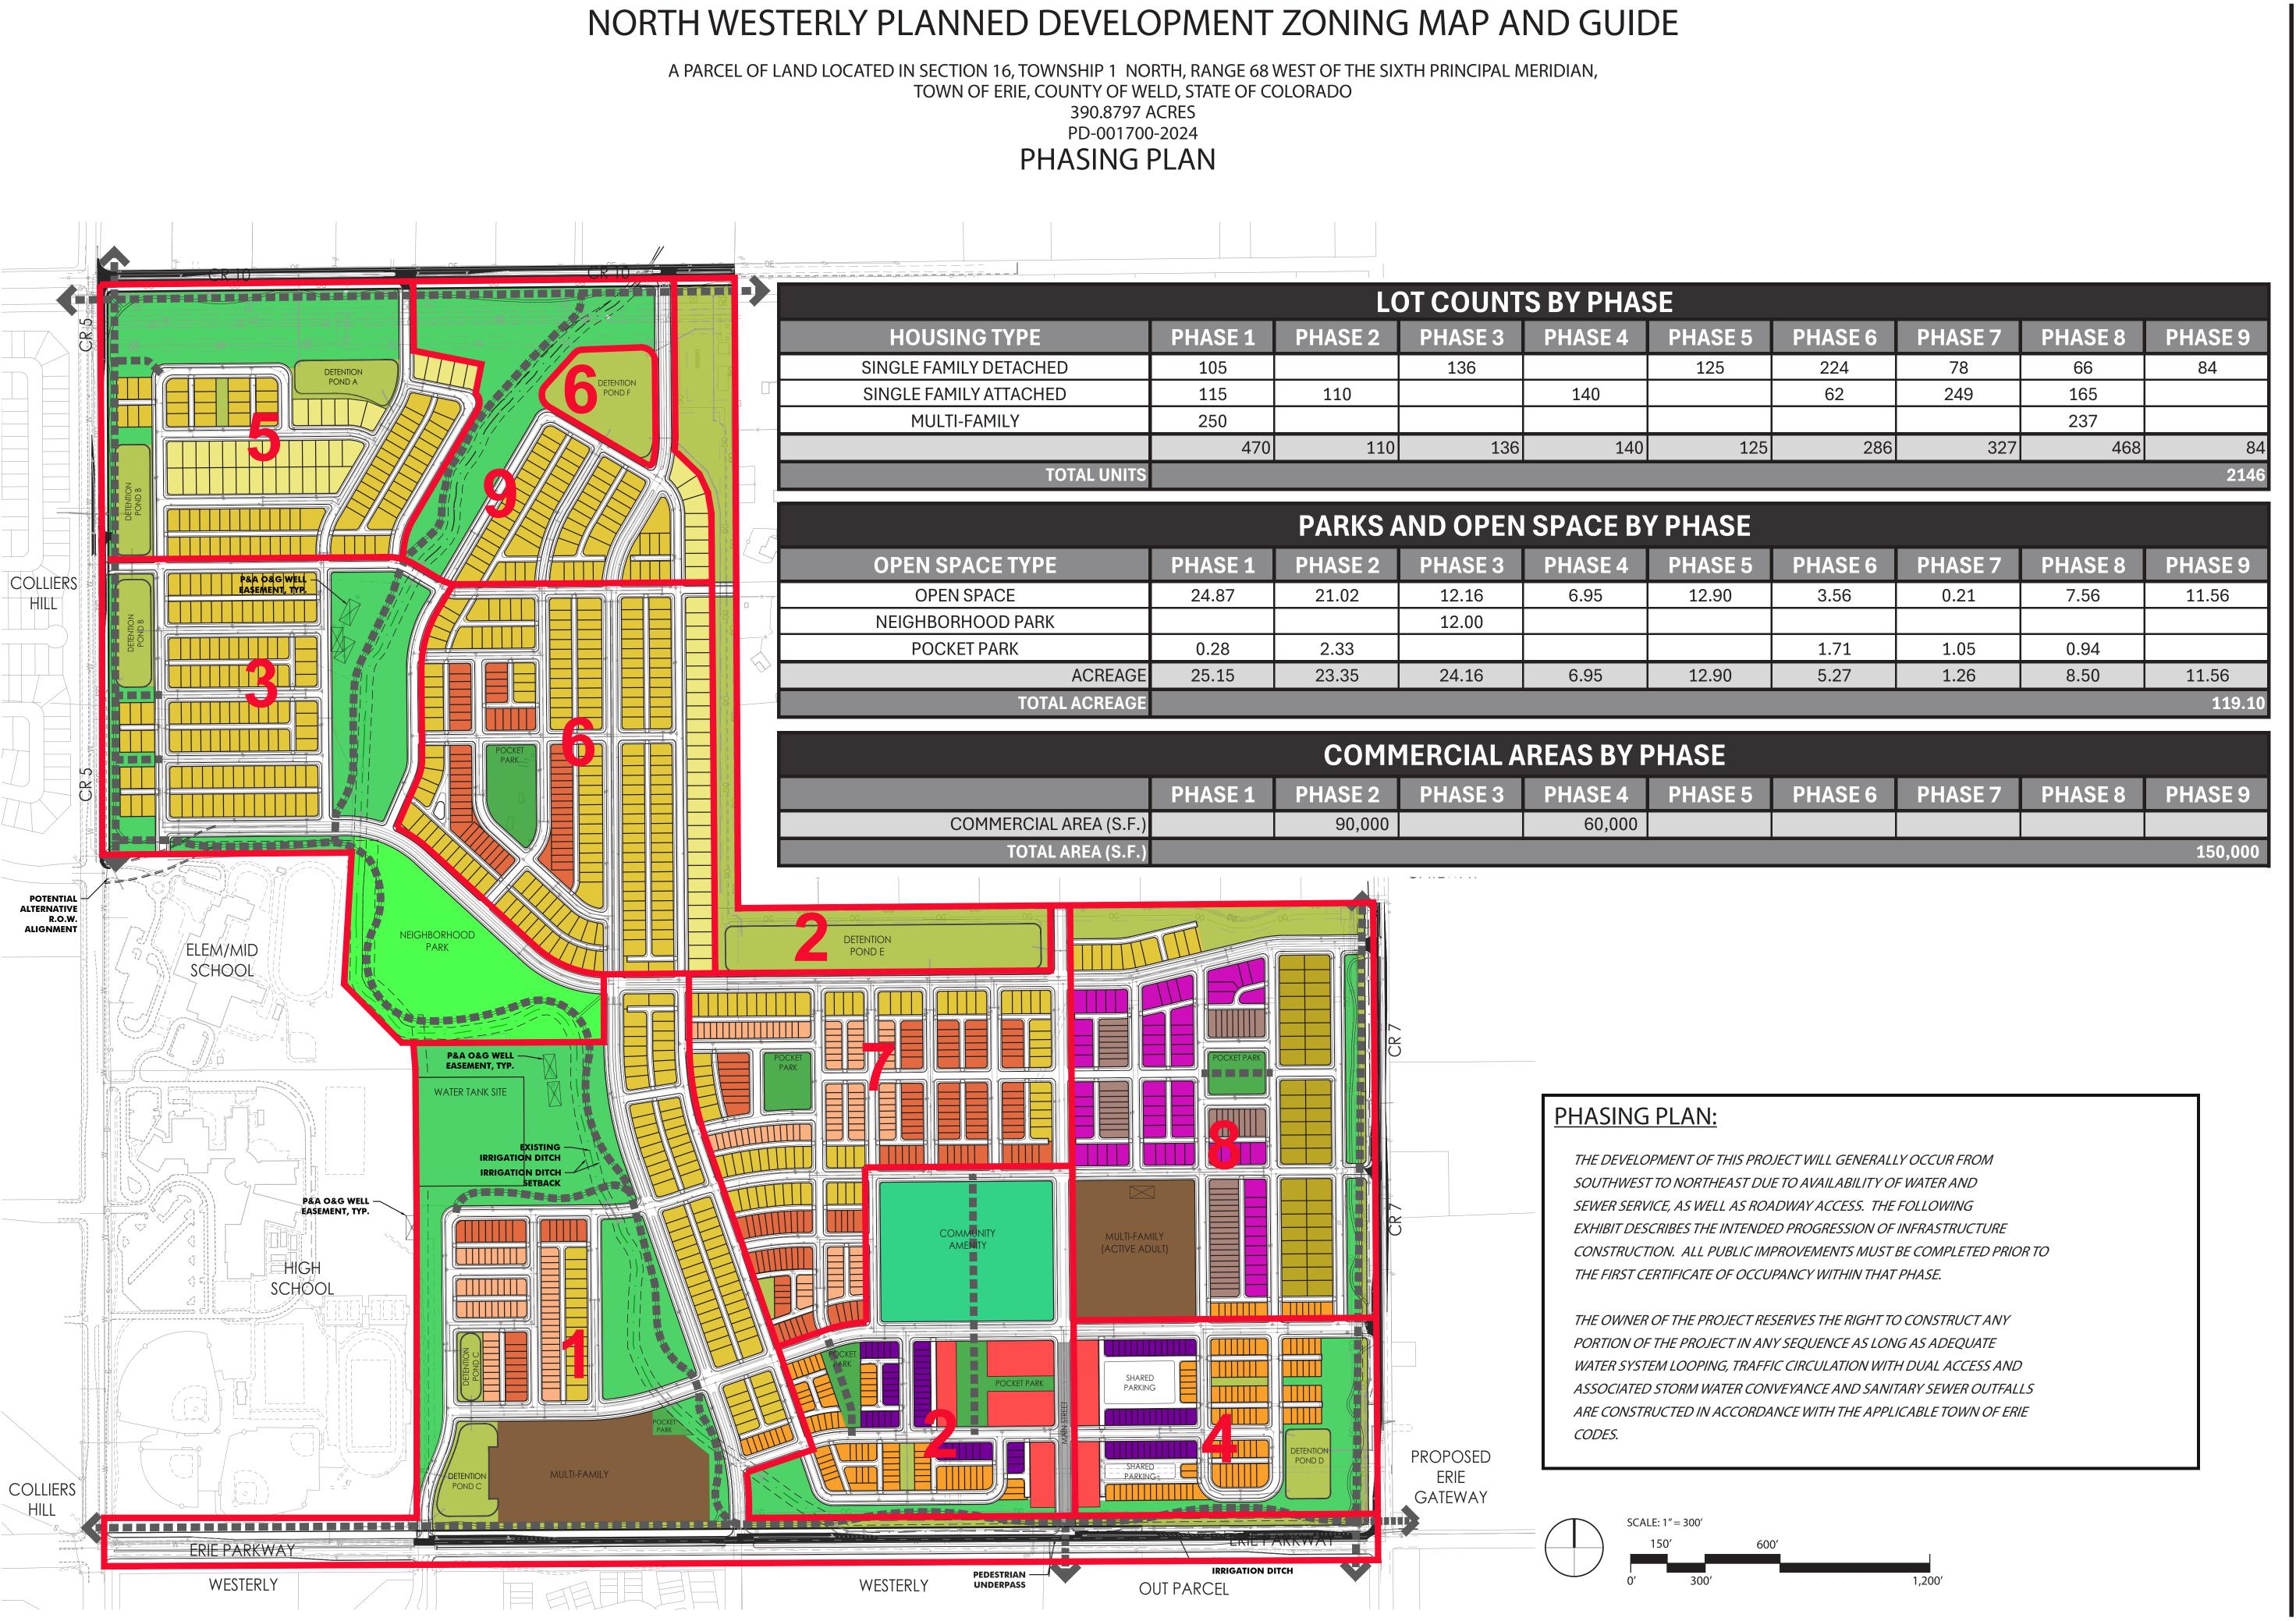PREPARED FOR:

NORTH WESTERLY

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CONTACT: JIM HENRY

ENGINEERING:



LAND PLANNING:

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 JP/CGR

 5TH SUBMITTAL
 4/18/2025
 JP/CGR

 6TH SUBMITTAL
 5/14/2025
 JP/CGR

SHEET INFO:

PHASING PLAN

DRAWN BY:

CGR

DESIGNED BY:

BC/SW

SUBMITTED ON: 2/09/2023

A PARCEL OF LAND LOCATED IN SECTION 16, TOWNSHIP 1 NORTH, RANGE 68 WEST OF THE SIXTH PRINCIPAL MERIDIAN,
TOWN OF ERIE, COUNTY OF WELD, STATE OF COLORADO
390.8797 ACRES
PD-001700-2024

ENVIRONMENTAL PLAN

Legend

Vegetation


- Tree
- Cropland
- Disturbed
- Mesic Graminoids
 Western Wet Shrubland
- Great Plains Ruderal
 Grassland & Shrubland

Mining

- Mine Shaft (hoisting shaft)
- Air Shaft
- – Inferred Bedrock Fault
- Upthrown Side
- Downthrown Side

Aquatic

- Culvert
- Community Ditch
- Flow Direction
- Palustrine Scrub Shrub Wetland

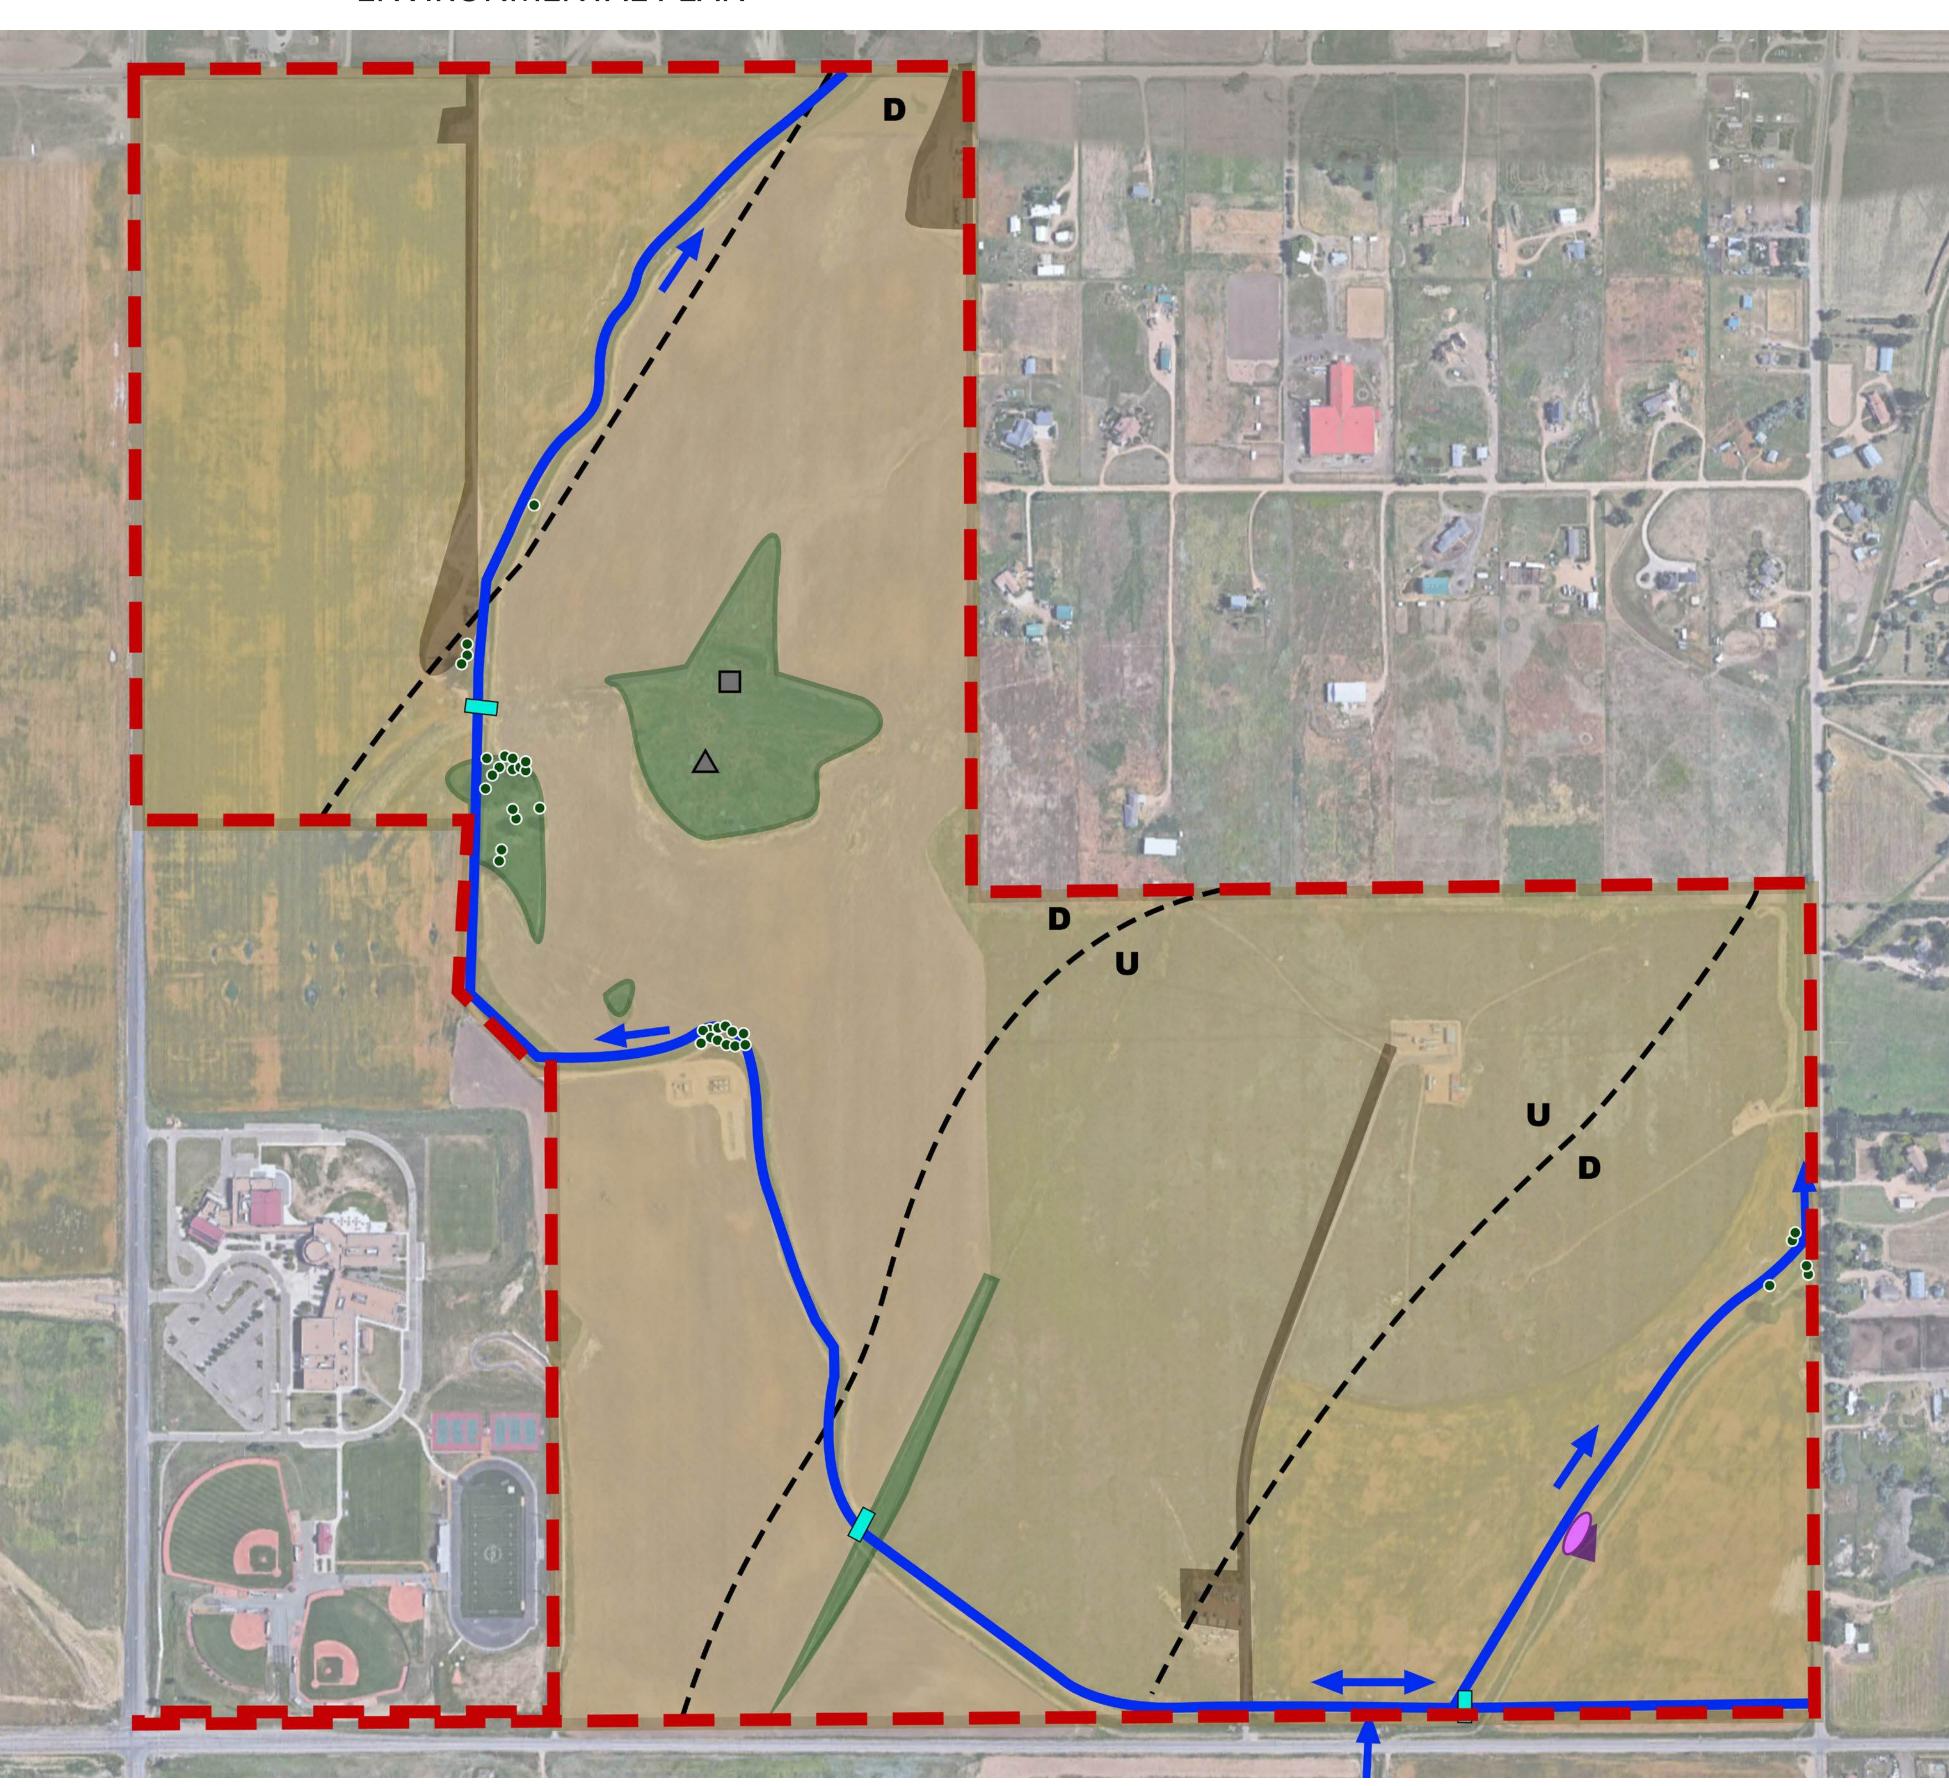



OWNER, LLC

3990 HILLSBORO PIKE,
SUITE 400,
NASHVILLE, TN 37215
720-531-8924

ENGINEERING:

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12500 W. 58TH AVE SUITE 230 ARVADA, CO 80002 720-638-5190 CONTACT: KEN TOLAND

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DENVER, CO - 80233
720-259-8246
CONTACT:
JOHN PRESTWICH

REVISIONS:

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SHEET INFO:

ENVIRONMENTAL PLAN

DRAWN BY:
CGR
DESIGNED BY:
BC/SW

SUBMITTED ON: 2/09/2023

