Print Form



TOWN OF ERIE

Community Development Department – Planning Division 645 Holbrook Street – PO Box 750 – Erie, CO 80516 Tel: 303.926.2770 – Fax: 303.926.2706 – Web: www.erieco.gov

LAND USE APPLICATION

Please fill in this form completely. Incomplete applications will not be processed. STAFF USE ONLY

FILE NO: DATE SI	UBMITTED: FEES PAID:			
Death Controlle				
PROJECT/BUSINESS NAME: Longs Peak Sprinkler				
PROJECT ADDRESS: Lot 8 Austin Industrial Park				
PROJECT DESCRIPTION: 4-Unit 6912 Sq Ft Metal Building	W/5512 Sq Ft of Outdoor Storage			
LEGAL DESCRIPTION (attach legal description if Metes & Bound	s)			
Subdivision Name: Austin Industrial Park				
Filing #: Lot #: 8 Block #:	Section: 19 Township: 1N Range: 68W			
OWNER (attach separate sheets if multiple)	AUTHORIZED REPRESENTATIVE			
Name/Company: Mike Amend	Company/Firm: Permontes Group			
Contact Person: Mike Amend	Contact Person:Mickey Leyba			
Address: 408 E. Geneseo Street	Address: 625 Main Street			
City/State/Zip: Lafayette, CO 80026	City/State/Zip:Longmont, CO 80501			
Phone: 303-665-1010 Fax: 303-666-1200	Phone:720-684-4981 Fax: 866-471-7369			
E-mail: longspeaksprinklers@comcast.net	E-mail: mleyba@permontesgroup.com			
MINERAL RIGHTS OWNER (attach separate sheets if multiple) Name/Company:	MINERAL LEASE HOLDER (attach separate sheets if multiple) Name/Company:			
Address	Address:			
City/State/Zip:	City/State/Zip:			
LAND-USE & SUMMARY INFORMATION				
Present Zoning: Light Industrial (LI)	Gross Site Density (du/ac):			
Proposed Zoning:	# Lots/Units Proposed:			
Gross Acreage: 42,200 SF	Gross Floor Area: 6912 SF			
SERVICE PROVIDERS				
Electric: XCEL Energy	Gas: XCEL Energy			
Metro District: N/A	Fire District: Mountain View Fire Rescue			
Water (if other than Town):	Sewer (if other than Town):			

PAGE TWO MUST BE SIGNED AND NOTARIZED

LAND USE APPLICATION FORM - 12 December 2007 Page 1 of 2

	DE\	VELOPMEN	T REVIEW FEES		
ANNEXATION			SUBDIVISION	Laker Start Carpy	
□ Major (10+ acres)	□ Major (10+ acres) \$ 4000.00		☐ Sketch Plan	\$ 1000.00 + 10.00 per lot	
☐ Minor (less than 10 acres	5)	\$ 2000.00	□ Preliminary Plat	\$ 2000.00 + 40.00 per lot	
□ Deannexation		\$ 1000.00	□ Final Plat	\$ 2000.00 + 20.00 per lot	
COMPREHENSIVE PLAN	MENDMENT		☐ Minor Subdivision Plat	\$ 2000.00	
□ Major	□ Major \$ 3000.00		☐ Minor Amendment Plat	\$ 1000.00 + 10.00 per lot	
□ Minor		\$ 1200.00	□ Road Vacation (constructed)	\$ 1000.00	
ZONING/REZONING	ONING/REZONING			\$ 100.00	
□ Rezoning	\$ 1700.00 + 1	10.00 per acre	SITE PLAN		
□ PUD Rezoning	\$ 1700.00 + 1	10.00 per acre	□ Residential	\$ 1400.00 + 10.00 per unit	
□ PUD Amendment	\$ 1700.00 + 1	0.00 per acre	□ Non-Resi. (>10,000 sq. ft.)	\$ 2200.00	
☐ Major PD Amendment	\$ 3700.00 + 1	.0.00 per acre	Non-Resi. (>2,000 sq. ft.)	\$ 1000.00	
□ Minor PD Amendment		\$ 500.00	□ Non-Resi. (<2,000 sq. ft.)	\$ 200.00	
SPECIAL REVIEW USE			☐ Amendment (major)	\$ 1100.00	
□ Major \$ 1000.00		☐ Amendment (minor)	\$ 350.00		
Minor		\$ 400.00	VARIANCE	\$ 600.00	
□ Oil & Gas \$ 1200		\$ 1200.00	SERVICE PLAN	\$ 10,000.00	

All fees **include** both Town of Erie Planning & Engineering review. These fees **do not include** referral agency review fees, outside consultant review fees, or review fees incurred by consultants acting on behalf of staff. See Town of Erie Municipal Code, Title 2-10-5 for all COMMUNITY DEVELOPMENT FEES.

The undersigned is fully aware of the request/proposal being made and the actions being initiated on the referenced property. The undersigned understand that the application must be found to be complete by the Town of Erie before the request can officially be accepted and the development review process initiated. The undersigned is aware that the applicant is fully responsible for all reasonable costs associated with the review of the application/request being made to the Town of Erie. Pursuant to Chapter 7 (Section 7.2.B.5) of the Unified Development Code (UDC) of the Town of Erie, applicants shall pay all costs billed by the Town for legal, engineering and planning costs incurred by staff, including consultants acting on behalf of staff, necessary for project review. By this acknowledgement, the undersigned hereby certify that the above information is true and correct.

certify that the above information is true and correct.		/ /
Owner: M. Mal J. Aron	Date:	5/3/10
Owner:	Date:	
Applicant: Michael T fry	Date:	
STATE OF COLORADO)		
County of Boulder) ss.		
The foregoing instrument was acknowledged before		
me this 3 rd day of May , 20 16,		
, 20.10,		
by Michael 1. Amend.		Λ

My commission expires: 3-16-19
Witness my hand and official seal.

LAND USE APPLICATION FORM - 12 December 2007

MICHELENE T. MILLER
NOTARY PUBLIC
STATE OF COLORADO
NOTARY ID 20154010711
COMMISSION EXPIRES MAR. 16, 2019

Page 2 of 2



SITE PLAN AND SPECIAL REVIEW USE SITE PLAN

460 Jones Court, Erie CO Lot 8 Austin Industrial Park

PROJECT NARRATIVE

a. General project concept and purpose of the request:

The proposed building will serve as an office/warehouse and takes advantage of the inherent utility and economies that a pre-engineered steel building offers. The building is located within a light industrial development comprised of buildings of similar type and appearance. The building will be comprised of 4-units in which unit 4 will be finished at the time of construction and occupied by the property owner's Longs Peak Sprinkler business. A 5,512 SF outdoor storage area adjacent to the south property line is also proposed for the use of Longs Peak Sprinkler. The additional three units will remain unfinished until leases are secured.

b. Discuss how the proposed development is in compliance with the five approval criteria of the Municipal Code Title 10 - UDC for Site Plan review and Special Use Review

Site Plan Review – Compliance with the approval Criteria of the Municipal Code Title 10

The Site Plan is generally consistent with the Town's Comprehensive Master Plan;

The proposed development for Lot 8 Austin Industrial Park is consistent with the Town's Comprehensive Master Plan. The building promotes a high standard of design which will provide opportunities for quality business and employment.

b. The Site Plan is generally consistent with any previously approved subdivision plat, planned development, or any other precedent plan or land use approval as applicable;

The Longs Peak Sprinkler Site Plan is consistent with Austin Industrial Park Final Plat.

 The Site Plan complies with all applicable development and design standards set forth in this UDC, including but not limited to the provisions in Chapter 2, Chapter 3, Chapter 4, and Chapter 6;

Longs Peak Sprinkler complies with the development and design standards set forth in the UDC for the Light Industrial zoning district.

d. Any significant adverse impacts reasonably anticipated to result from the use will be mitigated or offset to the maximum extent reasonably practicable; and

There will be no significant adverse impacts caused by the proposed development.

e. The development proposed on the Site Plan and its general location is or will be compatible with the character of surrounding land uses.

The Longs Peak Sprinkler Site Plan proposes a Light Industrial development that is compatible with the surrounding land uses. The 4-unit building will be occupied by the Land Owner's Landscape and irrigation company. The three additional units will remain unfinished until future leases are secured.

Special Review Use – Compliance with the approval Criteria of the Municipal Code Title 10

 The proposed use is generally consistent with the Town's Comprehensive Master Plan and all applicable provisions of this UDC and applicable State and Federal regulations;

The proposed development for Lot 8 Austin Industrial Park is consistent with the Town's Comprehensive Master Plan. The building promotes a high standard of design which will provide opportunities for quality business and employment.

b. The proposed use is generally consistent with the purpose and intent of the zoning district in which it is located;

The 4-unit office/warehouse building is consistent with the purpose and intent of the Light Industrial Zoning district.

c. The proposed use is generally consistent with any applicable use-specific standards set forth in Section 3.2;

The office/warehouse building is consistent with the Town's use-specific standards.

d. The proposed use is compatible with adjacent uses in terms of scale, site design, and operating characteristics (hours of operation, traffic generation, lighting, noise, odor, dust, and other external impacts);

The building is located within a light industrial development comprised of buildings of similar type and appearance. The proposed building is set to the interior of the development away from residential areas.

e. Any significant adverse impacts anticipated to result from the use will be mitigated or offset to the maximum extent reasonably practicable;

No significant adverse impacts on the natural environment are anticipated with development.

f. Facilities and services (including sewage and waste disposal, water, gas, election, police and fire protection, and streets and transportation, as applicable) will be available to serve the subject property while maintaining adequate levels of service for existing development;

Water and sanitary sewer services were stubbed to the property line with the overall development of Austin Industrial Park. Gas and electric is located within easements adjacent to the Jones Court right-of-way.

g. Adequate assurances of continuing maintenance have been provided; and

The property owner shall provide the overall maintenance for the building and site common space such as landscape areas, sidewalks, parking, drainage facilities, and parking/drive isles.

h. Any significant adverse impacts on the natural environment will be mitigated to the maximum extent reasonably practicable.

No significant adverse impacts on the natural environment are anticipated with development.

c. Architecture provides visual interest consistent with community's identity, character and scale:

The proposed building will serve as an office/warehouse and takes advantage of the inherent utility and economies that a pre-engineered steel building offers. The building is located within a light industrial development comprised of buildings of similar type and appearance. The proposed building is set to the interior of the development away from residential areas. The mass and form of the building is long and low, yielding a pleasing human scale, while maximizing the usefulness of the limited site area. Stone columns, entry canopies, and entrance patios will break up the elevations visible from the street. Earth tone colors allow the building to blend in to the generous landscaping planned for the site. The color and texture mix will provide a pleasing, warm, and welcoming feel to the pedestrian and others who approach. There will be shadow lines and visual relief provided by the projected columns and roof eave line. Overall, the proposed building along with the associated site improvements will complement and be consistent with the surrounding established community.

d. Development schedule:

Development shall consist of construction once final approvals of the Site Plan/Special Review Use Site plan and building permit plans are received from the town of Erie. Four (4) month duration is estimated for final completion of all site work and building construction. Construction is expected to begin fall of 2016 with an anticipated building occupancy prior to 2017.

e. General business information:

The 4-unit office/warehouse building will initially be occupied by Longs Peak Sprinkler. The additional 3 units will be tenant finished upon leasing. General business information for Longs Peak Sprinkle is as follows;

- Total building square footage is 5,912 SF
- Longs Peak Sprinkler will occupy Unit 4 which is 2,208 SF
- Units 2-4 will are each 1,568 SF and will be tenant finished upon leasing
- Longs Peak Sprinkler provides landscaping installation and maintenance as well as snow removal
- 6 employees may be on-site at any given time
- Business hours are typically 7:30am to 5:30 pm Monday through Friday
- Total project value is \$525K

f. Controls (location, function, and maintenance):

The property owner shall provide the overall maintenance for the building and site common space such as landscape areas, sidewalks, parking, drainage facilities, and parking/drive isles.

g. Substance of any existing or proposed covenants, special conditions, grand of easements, or other restrictions:

The Declaration of Protective Covenants for Austin Industrial Park Subdivision shall apply with the development of Lot 8. No additional covenants, grant of easements, of restrictions are proposed.

LEGAL DESCRIPTION:

LOT 8, AUSTIN INDUSTRIAL PARK, LOCATED IN THE SOUTHWEST QUARTER OF SECTION 19, TOWNSHIP 1 NORTH, RANGE 68 WEST OF THE 6TH P.M. TOWN OF ERIE, COUNTY OF WELD, STATE OF COLORADO

BASIS OF BEARINGS:

GPS DERIVED BEARINGS BASED ON A BEARING OF N01°14'08"E ALONG THE WEST LINE OF LOT 8, BETWEEN A FOUND NO. 4 REBAR W/ 1" RED PLASTIC CAP "AAI 23027" AT THE SOUTHWEST CORNER OF LOT 8 AND A FOUND NO. 4 REBAR W/ 1" RED PLASTIC CAP (ILLEGIBLE) AT THE NORTHWEST CORNER OF LOT 8 AS SHOWN HEREON. COLORADO STATE PLANE COORDINATE SYSTEM. COLORADO NORTH ZONE, NORTH AMERICAN DATUM 1983 (NAD83). ALL BEARINGS SHOWN HEREON ARE RELATIVE THERETO.

BENCHMARK INFORMATION:

GPS DERIVED BEARINGS BASED ON A BEARING OF N01°14'08"E ALONG THE WEST LINE OF LOT 8, BETWEEN A FOUND NO. 4 REBAR W/ 1" RED PLASTIC CAP "AAI 23027" AT THE SOUTHWEST CORNER OF LOT 8 AND A FOUND NO. 4 REBAR W/ 1" RED PLASTIC CAP (ILLEGIBLE) AT THE NORTHWEST CORNER OF LOT 8 AS SHOWN HEREON. COLORADO STATE PLANE COORDINATE SYSTEM, COLORADO NORTH ZONE, NORTH AMERICAN DATUM 1983 (NAD83). ALL BEARINGS SHOWN HEREON ARE RELATIVE THERETO.

PROPOSED DEVELOPMENT SCHEDULE

CONSTRUCTION TO BEGIN END OF JANUARY 2017. ANTICIPATED CONSTRUCTION TO LAST 7 MONTHS.

FLOODPLAIN INFORMATION

FIRM PANEL #08013CO443J EFFECTIVE DATE OF DECEMBER 18, 2012 SHOWS THAT THE PROPERTY LIES OUTSIDE THE 500-YEAR FLOODPLAIN OF COAL CREEK FLOODWAY IN FLOODWAY AREA ZONE X. FLOODWAY AREA ZONE X IS AREAS DETERMINED TO BE OUTSIDE 500-YEAR FLOODPLAIN DETERMINED TO BE OUTSIDE THE 1% AND 0.2% ANNUAL CHANCE FLOODPLAINS.


LOT 8, AUSTIN INDUSTRIAL PARK

LONGS PEAK SPRINKLER, 460 JONES COURT

LOCATED IN THE SOUTHWEST QUARTER OF SECTION 19, TOWNSHIP 1 NORTH, RANGE 68 WEST OF THE 6TH P.M. TOWN OF ERIE, COUNTY OF WELD, STATE OF COLORADO 0.97± ACRES

SITE PLAN - SP-000775-2016

SRU AREA - 0.97± ACRES - TOTAL AREA 0.97± ACRES SPECIAL REVIEW USE SITE PLAN - SRU-000774-2016

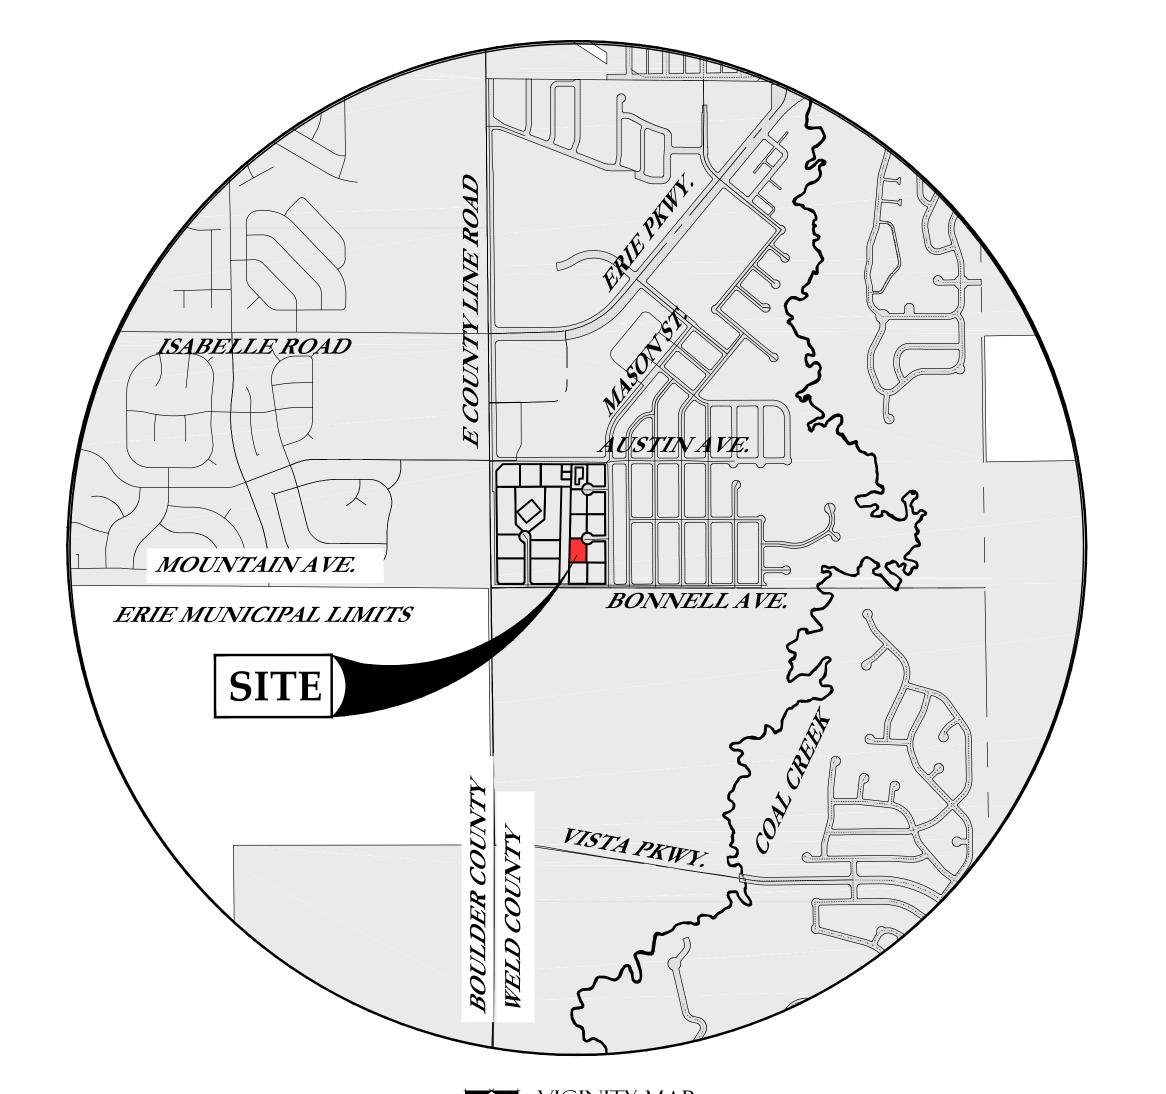

SPECIAL REVIEW USE SITE PLAN APPROVAL CERTIFICATE:

THIS SPECIAL REVIEW USE PLAN HAS □EEN REVIEWED AND FOUND TO □E COMPLETE AND IN ACCORDANCE WITH APPLICA LE TOWN OF ERIE REGULATIONS.

PLANNING COMMISSION - CHAIRMAN BOARD OF TRUSTEES - MAYOR

THE UNDERSIGNED AS THE OWNER OR OWNER'S REPRESENTATIVE OF THE LANDS DESCRIBED HEREIN, HEREBY AGREES ON BEHALF OF HIMSELF/HERSELF, THEIR HEIRS, SUCCESSORS, AND ASSIGNS TO DEVELOP AND MAINTAIN THE PROPERTY DESCRIBED HEREON IN ACCORDANCE WITH THIS APPROVED SITE PLAN AND IN COMPLIANCE WITH THE TOWN OF ERIE UNIFIED DEVELOPMENT CODE AND MUNICIPAL CODE.

OWNER SIGNATURE OWNER NAME PRINTED ACKNOWLEDGED BEFORE ME THIS

WITNESS MY HAND AND SEAL:

MY COMMISSION EXPIRES:

NOTARY PUBLIC

		DRAWING L

	4N 4 A D V OL LA D	-
SITE DATA SUN ZONE DISTRICT - LIG		•
ITEM SC	QUARE OOTAGE	PERCENT C GROSS SIT
GROSS SITE AREA:	42,200 S.F. (0.970 AC)	100 %
BUILDING FOOTPRINT:	6,912 S.F.	16.4 %
PARKING/ ROADS: DRIVEWAYS AND PARKING*:	18,600 S.F.	44.0%
OUTDOOR STORAGE AREA	<u>5,300 S.F.</u>	<u>12.7%</u>
HARDSCAPE TOTAL	31,022 S.F.	73.4%
 PLANTED AREA NON-LANDSCAPED (NATIVE SEED EXISTING VEGETATION TRAILS & SIDEWALKS 	6,529 S.F.) AREA 4,810 S.F. 	
LANDSCAPE TOTAL	6,529 S.F.	15.5%
ITEM DE	ESCRIPTION	
BUILDING SIZE: 1 STORY • AN UNDETERMINED MIX OF OFF AND/ OR LIGHT INDUSTRIAL	ICE 6,912 S	S.F.
TOTAL	6,912 \$	S.F.
PARKING		

TOTAL REQUIRED (OFFICE 1/300 S.F.)

HANDICAP PROVIDED

• TOTAL PROVIDED (INCLUDING HANDICAP) 23 SPACES

23 SPACES

1 SPACE

DRAWING LEGEND			
	EXISTING	PROPOSED	WATER ME BACKFLOV
ROW OR PROPERTY LINE			SUMP PIT
SECTION LINE			GATE VAL
CENTER LINE			FIRE HYDR
EASEMENT LINE			DOWNSPO
CONTOURS		4685 4684	ELECTRIC
SANITARY SEWER LINE		S/L	TELEPHON
SANITARY SERVICE LINE	SS	ss	UTILITY PO
STORM DRAIN LINE			LIGHT POL
WATER LINE		W/L	SECTION C
WATER SERVICE LINE		——— WS ———	SURVEY M
ELECTRIC LINE	——— E ———	E	33
OVERHEAD ELEC LINE	OHE	———— OHE ————	ASPHALT F
UNDERGROUND ELEC LINE	UGE	———— UGE ————	
GAS LINE	G	G	GRAVEL D
TELEPHONE LINE	T	T	
OVERHEAD TEL LINE	OHT	———— OHT ————	CONCRETE
UNDERGROUND TEL LINE	——— UGT ———	———— UGT ————	
FIBER OPTIC LINE	FO	——— FO ———	RIPRAP
SANITARY MANHOLE	<u> </u>	———	
STORM DRAIN MANHOLE			BUILDING
DRAINAGE SWALE		· · ·	
CURB & GUTTER			PEDESTAL
BARB-WIRE FENCE	X	X	PEDESTAL
CHAIN-LINK FENCE			RECORDE
WOOD FENCE			MEASURE
RR TRACKS	-	 	
SANITARY CLEANOUT	co	co	DETAIL/SE
STORM DRAIN INLET (TYPE "R"	()		

STORM DRAIN INLET (TYPE "C")

WATER METER		M
BACKFLOW PREVENTER	- (3) (0)	- ₩Ø
SUMP PIT		
GATE VALVE	\bowtie	\bowtie
FIRE HYDRANT		~
DOWNSPOUT DRAIN	\ominus	\odot
ELECTRIC TRANSFORMER		
TELEPHONE PEDESTAL		
UTILITY POLE	0	D
LIGHT POLE	# ;	* 🕏
SECTION CORNER	�	�
SURVEY MARKER/MONUMENT	0	•
ASPHALT PAVING		
GRAVEL DRIVE		
CONCRETE PAVEMENT		A A A A
RIPRAP		
BUILDING		
PEDESTAL POLE & MASTARM		*
PEDESTAL POLE & SIGNAL HEA	ADS	~~ #
RECORDED BRG/DIST PER PLA	T (F	P)
MEASURED BRG/DIST	•	, Л)

OWNER/APPLICANT

OWNER APPLICANT ... MIKE AMEND 1□5 WIGGETT CT ERIE, CO 80516

TECHNICAL CONSULTANTS

SURVEYING FLATIRONS, INC. 655 FOURTH AVE. LONGMONT, CO. 80501 PHONE0776-17 CONTACT JESS KUNT

PLANNING ENGINEERING PERMONTES GROUP 625 MAIN STREET LONGMONT, CO 80501 PHONE 1720 684-4981 CONTACT MICKEY LEY A

GEOTECHNICAL ENGINEERING KUMAR & ASSOCIATES, INC. 2390 SOUTH LIPAN STREET

DENVER, CO 80223 PHONE:(303) 742-9700 CONTACT: KEN MENDENHALL $\mathsf{MLEY} \square \mathsf{A} \square \ \mathsf{PERMONTESGROUP.COM} \qquad \mathsf{www.kumarusa.com}$

> THE CONTRACTOR SHALL LOCATE AND VERIFY ALL EXISTING UTILITY LOCATIONS PRIOR TO CONSTRUCTION

SHEET INDEX C1 COVER SHEET

C2 SITE PLAN

C3 UTILITY PLAN C4 GRADING PLAN

C5 DRAINAGE & ER CONTROL PLAN

C6 DRAINAGE & ER CONTROL NOTES

C7 DETAILS - CIVIL DETAILS I

C8 LANDSCAPE PLAN

C9 LANDSCAPING SCHEDULES

C10 ELECTRICAL SITE PHOTOMETRIC PLAN (BY OTHERS)

A-1 FLOOR PLAN SHEET (BY OTHERS) A-2 ELEVATIONS SHEET (BY OTHERS)

A-3 ELEVATIONS SHEET (BY OTHERS)





COVER SHEET

8, AUSTIN INDUSTRIAL PARK

0 JONES COURT, ERIE, CO

MIKE AMEND

SDW $\mathsf{DRAWN} \; \Box \mathsf{Y} \Box$ ML CHECKED $\Box Y \Box$ APPROVED \(\text{Y} \) JHP

PROJECT NO.□ 197.001 $\mathsf{DATE}\,\square$ 51101**2**016 AS SHOWN SCALE

SHEET NO.

SHEET 1 OF 1□

		EDGE C	F PAVEME	ENT LINE TABL	E		
LINE#	LENGTH	DIRECTION	STAR	T POINT (N,E)	END	POINT (N,E)	
L1	19.43	N70°01'07"E	(1254689	.07, 3126334.36)	(1254695	.71, 3126352.62	
L2	75.96	S89°59'35"E	(1254687	.58, 3126249.85)	(1254687	.57, 3126325.81	
L3	12.30	N00°00'25"E	(1254675	.28, 3126249.85)	(1254687	.58, 3126249.85	
L4	13.25	N89°59'35"W	(1254675	.28, 3126249.85)	(1254675	.28, 3126236.60	
L5	16.54	N00°00'25"E	(1254658	.74, 3126236.59)	(1254675	.28, 3126236.60	
L6	17.00	S89°59'35"E	(1254655	.74, 3126216.59)	(1254655	.74, 3126233.59	
L7	36.00	N00°00'25"E	(1254619	.74, 3126216.59)	(1254655	.74, 3126216.59	
L8	17.00	N89°59'35"W	(1254619	.74, 3126233.59)	(1254619	.74, 3126216.59	
L9	3.00	N00°00'25"E	(1254613	.74, 3126236.59)	(1254616	.74, 3126236.59	
L10	17.00	S89°59'35"E	(1254610	.74, 3126216.59)	(1254610	.74, 3126233.59	
L11	36.00	N00°00'25"E	(1254574	.74, 3126216.59)	(1254610	.74, 3126216.59	
L12	17.00	N89°59'35"W	(1254574	.74, 3126233.58)	(1254574	.74, 3126216.58	
L13	3.00	N00°00'25"E	(1254568	.74, 3126236.58)	(1254571	.74, 3126236.58	
L14	7.00	S89°59'35"E	(1254565	.74, 3126226.58)	(1254565	.74, 3126233.58	
L15	60.00	N00°00'25"E	(1254505	(1254505.74, 3126226.58)		(1254565.74, 3126226.58	
L16	39.00	N89°59'35"W	(1254505	.74, 3126265.58)	(1254505	.74, 3126226.58	
L17	15.00	S00°00'25"W	(1254520	(1254520.74, 3126265.58) (1254505.74		.74, 3126265.58	
L18	10.00	S89°59'35"E	(1254520	.74, 3126255.58)	(1254520	.74, 3126265.58	
L19	10.00	S00°00'25"W	(1254530	.74, 3126255.58)	(1254520	.74, 3126255.58	
L20	10.00	N89°59'35"W	(1254530	.74, 3126265.58)	(1254530	.74, 3126255.58	
L21	3.49	S00°00'25"W	(1254534	.23, 3126265.58)	(1254530	.74, 3126265.58	
L22	12.00	S89°59'35"E	(1254534	.23, 3126253.58)	(1254534	.23, 3126265.58	
L23	12.00	S00°00'25"W	(1254546	.23, 3126253.58)	(1254534	.23, 3126253.58	
L24	12.00	N89°59'35"W	(1254546	.23, 3126265.58)	(1254546	.23, 3126253.58	
L25	20.16	S00°00'25"W	(1254566	.40, 3126265.58)	(1254546	.23, 3126265.58	
L26	12.00	S89°59'35"E	(1254566	.40, 3126253.58)	(1254566	.40, 3126265.58	
L27	12.00	S00°00'25"W	(1254578	.40, 3126253.59)	(1254566	.40, 3126253.58	
L28	12.00	N89°59'34"W	(1254578	.40, 3126265.59)	(1254578	.40, 3126253.59	
L29	20.67	S00°00'20"W	(1254599	.06, 3126265.59)	(1254578	.40, 3126265.59	
L30	12.00	S89°59'35"E	(1254599	.07, 3126253.59)	(1254599	.06, 3126265.59	
		EDG	E OF PAVE	EMENT CURVE	TABLE		
CURVE	# RADIUS	LENGTH	DELTA	STARTING POI	NT (N,E)	END POI	
C1	5.58	4.99	51°13'32"	(1254695.71, 31	26352.62)	(1254699.25,	
C2	25.00	8.72	19°59'18"	(1254687.57, 31)	26325.81)	(1254689.07,	
	1	· ·		1		i	


		EDG	E OF PAVE	EMENT CURVE TABLE	
CURVE#	RADIUS	LENGTH	DELTA	STARTING POINT (N,E)	END POINT (N,E)
C1	5.58	4.99	51°13'32"	(1254695.71, 3126352.62)	(1254699.25, 3126355.91
C2	25.00	8.72	19°59'18"	(1254687.57, 3126325.81)	(1254689.07, 3126334.36
C4	3.00	4.71	90°00'00"	(1254655.74, 3126233.59)	(1254658.74, 3126236.59
C5	3.00	4.71	90°00'00"	(1254616.74, 3126236.59)	(1254619.74, 3126233.59
C6	3.00	4.71	90°00'00"	(1254610.74, 3126233.59)	(1254613.74, 3126236.59
C7	3.00	4.71	90°00'00"	(1254571.74, 3126236.58)	(1254574.74, 3126233.58
C8	3.00	4.71	90°00'00"	(1254565.74, 3126233.58)	(1254568.74, 3126236.58
C9	10.00	15.71	90°00'00"	(1254663.57, 3126270.60)	(1254653.58, 3126260.59
C10	10.00	15.71	90°00'00"	(1254653.57, 3126323.59)	(1254663.57, 3126313.60
C11	3.00	4.71	90°00'00"	(1254472.73, 3126323.57)	(1254475.73, 3126320.57
C12	1.55	2.12	78°42'24"	(1254466.99, 3126349.07)	(1254465.73, 3126347.57
C13	3.00	4.71	90°00'00"	(1254541.99, 3126347.58)	(1254538.99, 3126350.58
C14	3.00	4.71	90°00'00"	(1254547.99, 3126350.58)	(1254544.99, 3126347.58
C15	3.00	4.71	89°59'37"	(1254622.99, 3126347.59)	(1254619.99, 3126350.59
C16	5.00	6.11	70°02'44"	(1254669.55, 3126350.89)	(1254664.85, 3126347.60
C17	4.54	6.12	77°15'05"	(1254670.23, 3126362.17)	(1254671.65, 3126356.68
C18	33.13	13.84	23°56'19"	(1254699.25, 3126355.91)	(1254685.51, 3126355.42


1 1/2" O.D. BENT STEEL PIPE

(4) 1 1/2" O.D. BENT-


TYP. SPACING

STEEL PIPES

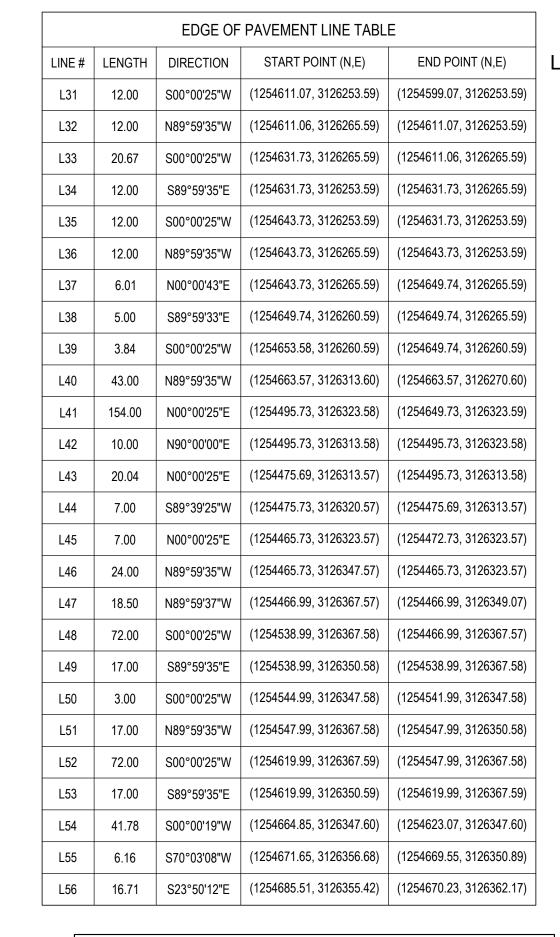

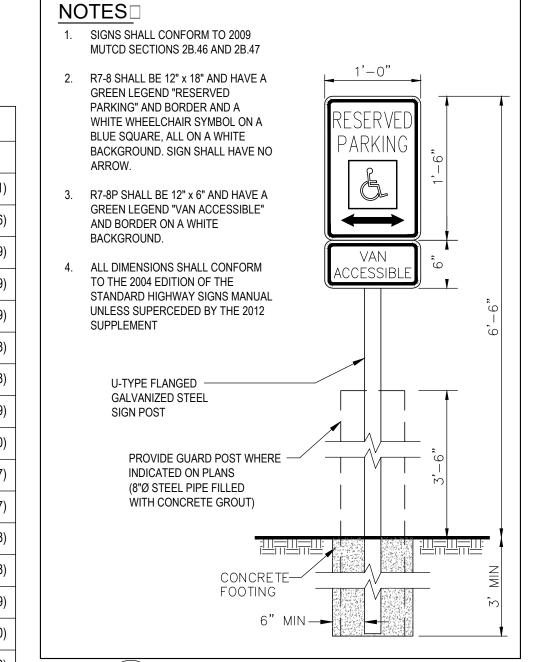

ACCESSI LE PARKING SIGN

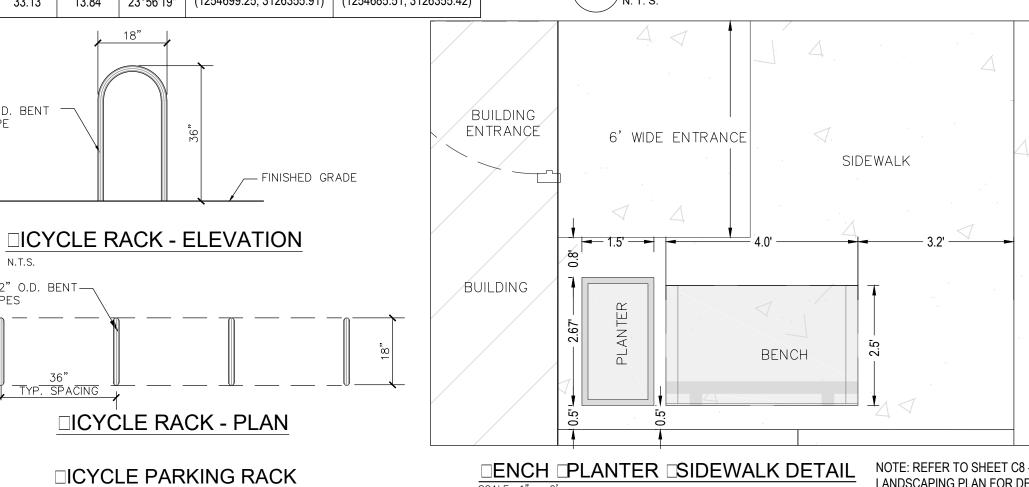

LOT 8, AUSTIN INDUSTRIAL PARK

LONGS PEAK SPRINKLER, 460 JONES COURT LOCATED IN THE SOUTHWEST QUARTER OF SECTION 19, TOWNSHIP 1 NORTH, RANGE 68 WEST OF THE 6TH P.M. TOWN OF ERIE, COUNTY OF WELD, STATE OF COLORADO

0.97± ACRES

METER CENTER

L10 2 公司

18

20' KMCG PIPE LINE RIGHT-OF-WAY PER

RECEPTION NO. 2750214

FOUND -

"AAI 23027"

L36

L32

L24

OUTDOOR STORAGE AREA

12 50'± x 95'±

8' UTILITY AND

8' UTILITY AND

DRAINAGE EASEMENT

DRAINAGE EASEMENT --

UNIT 4

1,568 S.F.

48.00'

PROPOSED

1-STORY

BUILDING AREA = 6,912 S.F.

UNIT 3

1,568 S.F. ₹

48.00'

1,568 S.F.


48.00'

UNIT 1

2,208 S.F.

OVERHANG (LEAN-TO) 12'x32'

4 UNIT INDUSTRIAL

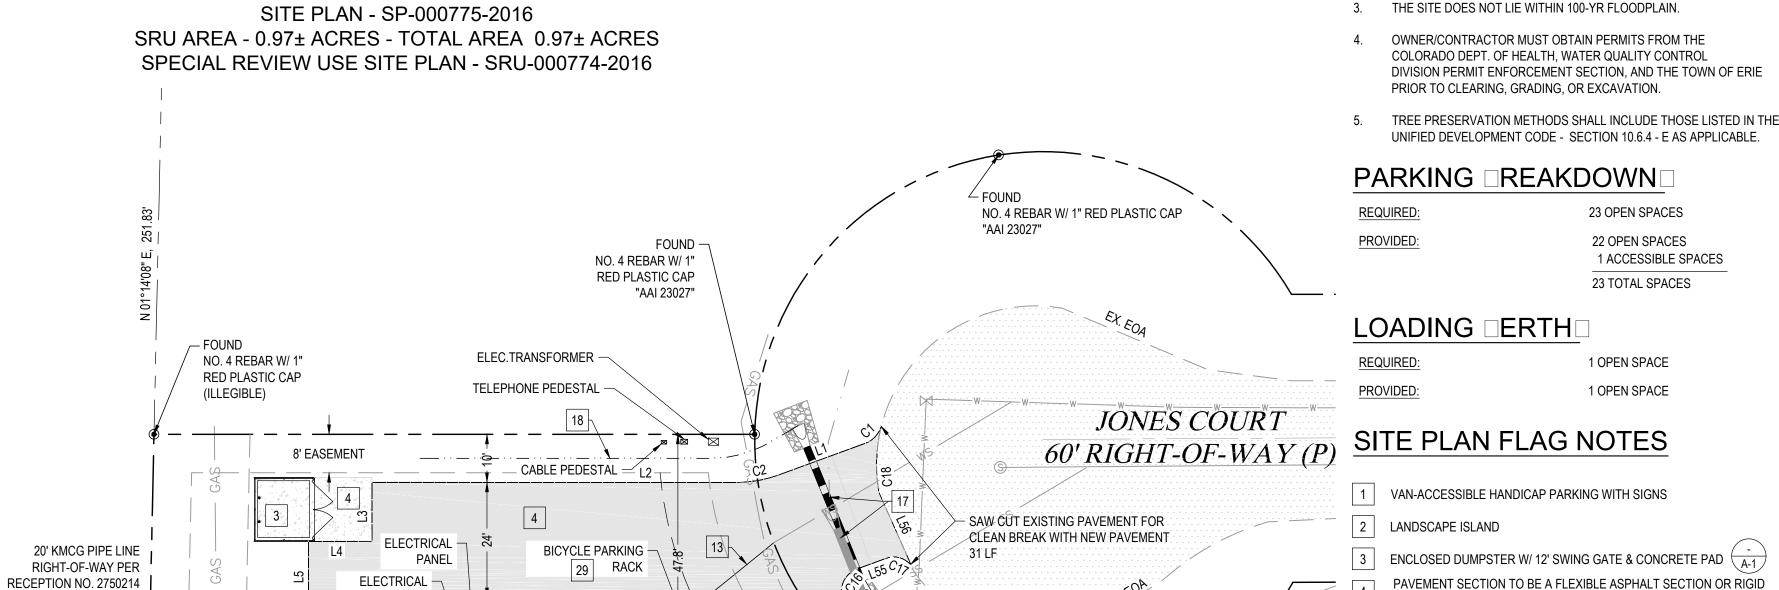

SIDEWALK

RISER PIPE

- EX. FIRE HYDRANT

— FOUND

NO. 4 REBAR

EDGE OF PAVEMENT

- OVERFLOW WEIR

2' WIDE X 2.5' LONG - 19.3' LONG

6" PVC DRAIN PIPE -

PROPOSED 6' WIDE GRASS -

SWALE - SLOPED @ 0.35%

NO.|4 REBAR W/ 1"

RED PLASTIC CAP

"AA| 23027"

- EX. DRAINAGE

PARKING | REAKDOWN

SITE NOTES

1. PROPERTY IS ZONED 'LIGHT INDUSTRIAL' (LI).

2. THERE ARE NO MAJOR DRAINAGE WAYS AFFECTING THE SITE.

COLORADO DEPT. OF HEALTH, WATER QUALITY CONTROL

PRIOR TO CLEARING, GRADING, OR EXCAVATION.

DIVISION PERMIT ENFORCEMENT SECTION, AND THE TOWN OF ERIE

UNIFIED DEVELOPMENT CODE - SECTION 10.6.4 - E AS APPLICABLE.

23 TOTAL SPACES

23 OPEN SPACES PROVIDED: 22 OPEN SPACES 1 ACCESSIBLE SPACES

LOADING DERTH

REQUIRED: 1 OPEN SPACE PROVIDED: 1 OPEN SPACE

SITE PLAN FLAG NOTES

1 VAN-ACCESSIBLE HANDICAP PARKING WITH SIGNS

2 LANDSCAPE ISLAND

3 ENCLOSED DUMPSTER W/ 12' SWING GATE & CONCRETE PAD (A-1) PAVEMENT SECTION TO BE A FLEXIBLE ASPHALT SECTION OR RIGID CONCRETE SECTION AS RECOMMENDED IN THE "GEOTECHNICAL ENGINEERING STUDY AND PAVEMENT THICKNESS DESIGN PROPOSED AUSTIN INDUSTRIAL PARK BUILDING 460 JONES COURT ERIE, CO."

PREPARED BY KUMAR & ASSOCIATES, INC., DATED JUNE 24, 2016.

5 ACCESS MAN DOOR (TYP.)

6 PERIMETER FENCING (A-2)

7 12' X 16' OVERHEAD SLIDING DOOR 8 14' SWING GATE $\frac{-}{A-2}$

9 10' X 60' LOADING BERTH

10 20' BUILDING SETBACK

11 10'X10' CONCRETE PAD

11A 15'X10' CONCRETE PAD

11B 12'X10' CONCRETE PAD

0UTDOOR STORAGE AREA TO BE RECYCLED ASPHALT OR RECYCLED CONCRETE

13 1" WATER SERVICE

1" WATER METER $\begin{pmatrix} 2 & \sqrt{3} \\ C7 & \sqrt{C7} \end{pmatrix}$

15 NATURAL GAS SERVICE METERS

16 4" SANITARY SEWER SERVICE

17 15" RCP STORM PIPE W/ FES TO BE REMOVED & REPLACED (A)

19 PARKING ASPHALT CURB STOP

20 BOLLARDS LOCATED ON EACH END OF OVERHEAD DOORS (10 TOTAL)

21 FLAGSTONE MONUMENT SIGN (APPROXIMATELY 4'x6')

22 ROOF DRAINS (10 TOTAL)

[23] FLOW METER/ SAMPLING STATION $\left(\frac{1}{C7}\right)$

24 REDUCED PRESSURE ASSEMBLY $\left(\frac{2}{C7}\right)$

25 CURB RAMP TYPE 1 DETAIL SW5 $\left(\frac{4}{C7}\right)$

26 WATER QUALITY POND

27 ACCESSIBLE PARKING SIGN $\frac{A}{C2}$

28 PLANTER BOX AND SITTING BENCH $\left(\frac{1}{C8}\right)$

APPROXIMATE LOCATION OF FUTURE AC/HEATER LOCATION (3'-6" WIDE X 1'5" HIGH)

(1' - 10 1/2" FROM GROUND)

29 BICYCLE PARKING RACK $\frac{B}{C2}$

31 AC/HEATER LOCATION SCALE □1" □ 20 □

> THE CONTRACTOR SHALL LOCATE AND VERIFY ALL EXISTING UTILITY LOCATIONS PRIOR TO CONSTRUCTION

SITE PLAN
, AUSTIN INDUSTRIAL F
JONES COURT, ERIE, (MIKE AMEND

 $\mathsf{DESIGNED} \ \Box \mathsf{Y} \Box$ SDW $\mathsf{DRAWN} \; \Box \mathsf{Y} \Box$ $\mathsf{CHECKED} \ \Box \mathsf{Y} \Box$ APPROVED DYD JHP


PROJECT NO. 197.001 0511012016

AS SHOWN SCALE SHEET NO.

SHEET 2 OF 1□

NO. 4 REBAR W/ 1" RED PLASTIC CAP

LANDSCAPING PLAN FOR DETAILS

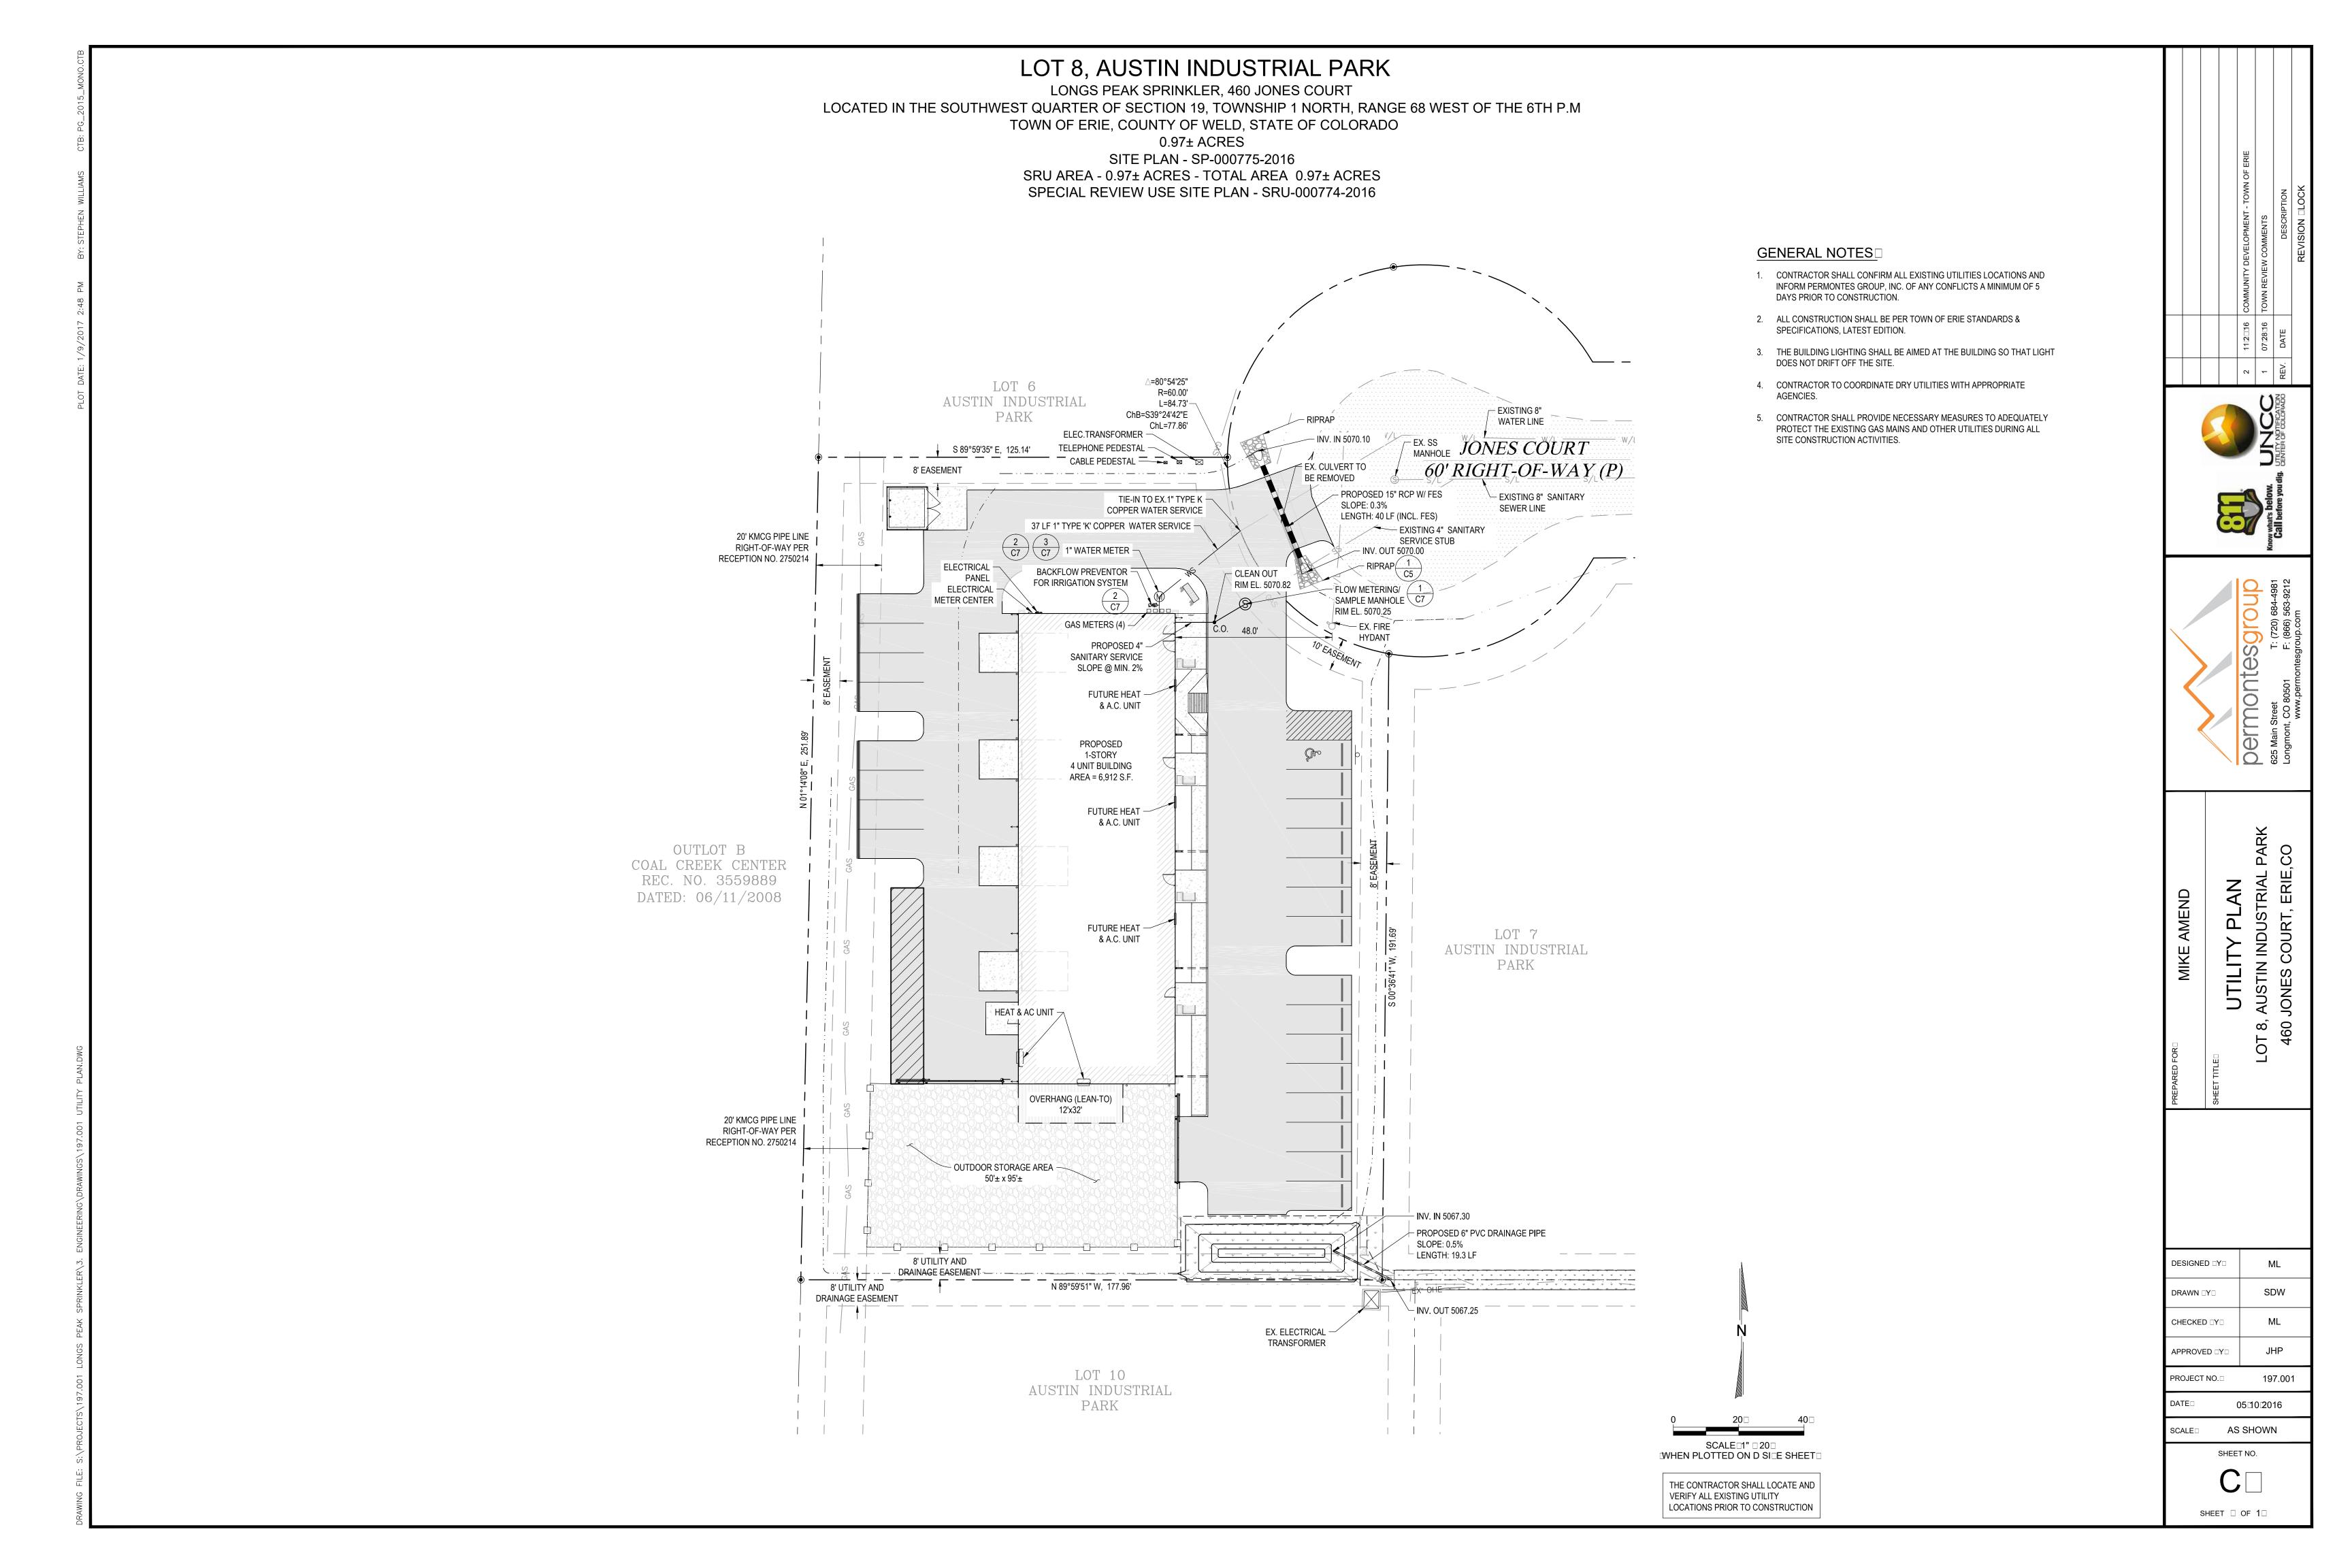

LOT 8, AUSTIN INDUSTRIAL PARK LONGS PEAK SPRINKLER, 460 JONES COURT LOCATED IN THE SOUTHWEST QUARTER OF SECTION 19, TOWNSHIP 1 NORTH, RANGE 68 WEST OF THE 6TH P.M. TOWN OF ERIE, COUNTY OF WELD, STATE OF COLORADO 0.97± ACRES SITE PLAN - SP-000775-2016 SRU AREA - 0.97± ACRES - TOTAL AREA 0.97± ACRES SPECIAL REVIEW USE SITE PLAN - SRU-000774-2016

*7*80°54'25"

AUSTIN INDUSTRIAL

PROPOSED DRAINAGE SWALE @ 0.5% SLOPE -

__5070.23 EOC

5071.84 EOA

OUTDOOR STORAGE AREA

50'± x 95'±

5070.39

8' UTILITY AND DRAINAGE EASEMENT - DRAINAGE

PROPOSED

DRAINAGE SWALE

@ 0.4% SLOPE

EOA

2.3%

25% 5071.00

20\KMCG PIPE LINE

RECEPTION NO. 2750214

OUTLOT B

COAL CREEK CENTER, REC. NO. 3559889

DATED: 06/11/2008

PROPOSED DRAINAGE SWALE @ 1.0% -

SLOPE GRADE BREAK ELEV = 5068.86

PROPOSED DRAINAGE -

SWALE @ 0.9% SLOPE

20' KMCG PIPE LINE

PROPOSED DRAINAGE -

5068.55

5068.45 __ 8' UTILITY AND

SWALE @ 0.4% SLOPE GRADE BREAK ELEV =

RECEPTION NO. 2750214

RIGHT-OF-WAY PER

RIGHT-OF-WAY PER

R=60.00'

L=84.73'-

5069.98

EOA

5070.67

5071.17

EOA 5070.20

5069 64

EOA

5069.98

EOA

5070.03

EOA

2.9%

6" PVC —

RISER PIPE

WATER QUALITY POND /

TEMPORARY SEDIMENT

BASIN,SB

JONES COURT

60' RIGHT-OF-WAY (P

- PROPOSED

DRAINAGE

SWALE @2.3% SLOPE

PROPOSED DRAINAGE

SWALE @ 0.5% SLOPE

2' WIDE X 2.5' LONG - 19.3' LONG 6" PVC

-DRAIN PIPE -

LOT 7

AUSTIN INDUSTRIAL

PARK

PROPOSED 6' WIDE GRASS

SWALE - SLOPED @ 0.35%

LOT 9

AUSTIN INDUSTRIAL

PARK

ChB=S39°24'42"E

EOC 5071.19

PROPOSED

1-STORY 4 UNIT INDUSTRIAL BUILDING

AREA = 6,912 S.F. FF EL: 5071.84

OVERHANG (LEAN-TO)

12'x32'

DRAINAGE

LOT 10

AUSTIN INDUSTRIAL

PARK

SWALE

5071.67

5071.67

EOC 7

EOA 🐬

5071.38


ChL=77.86'

GRADING NOTES

- ADA PARKING SPACES SHALL NOT EXCEED 5% LONGITUDINAL SLOPE OR 2% CROSS SLOPE AT ANY POINT.
- 2. SITE DOES NOT LIE WITHIN 100-YR FLOODPLAIN PER FIRM PANEL NO. 08013CO4435, DATED DECEMBER 18, 2012.
- 3. ALL EARTHWORK TO BE INSTALLED IN ACCORDANCE WITH RECOMMENDATIONS SPECIFIED IN THE SOILS REPORT GEOTECHNICAL ENGINEERING REPORT, PREPARED BY KUMAR & ASSOCIATES, DATED MAY, 2016, AND THE TOWN OF ERIE STANDARDS.
- 4. ALL ASPHALT SHALL BE IN ACCORDANCE WITH THE RECOMMENDATIONS SPECIFIED IN THE GEOTECHNICAL ENGINEERING REPORT, PREPARED BY KUMAR & ASSOCIATES, DATED MAY, 2016.
- 5. COMPACT ALL FILL PER SOILS ENGINEER.
- DURING CONSTRUCTION, WHETHER SHOWN ON THESE PLANS OR NOT. CONTRACTOR SHALL CONTACT REPRESENTATIVES OF THE RESPECTIVE UTILITIES AND HAVE ALL UTILITIES FIELD LOCATED PRIOR TO CONSTRUCTION. IT SHALL BE THE CONTRACTOR'S RESPONSIBILITY TO VERIFY ALL LOCATIONS OF EXISTING STRUCTURES AND UTILITIES SHOWN ON THE DRAWINGS, TO ASCERTAIN WHETHER ANY STRUCTURES AND UTILITIES MAY EXIST, AND REPAIR AND/OR REPLACE ANY STRUCTURES AND/OR UTILITIES THAT ARE DAMAGED BY THE CONTRACTOR.
- CONTRACTOR TO FOLLOW ALL RECOMMENDATIONS FROM THE GEOTECHNICAL REPORT, "GEOTECHNICAL ENGINEERING STUDY AND PAVEMENT THICKNESS DESIGN PROPOSED AUSTIN INDUSTRIAL PARK BUILDING 460 JONES COURT ERIE, CO." PREPARED BY KUMAR & ASSOCIATES, INC., DATED JUNE 24, 2016.
- ALL FILL MATERIAL AND PLACEMENT OF FILL BELOW THE BUILDINGS TO BE REVIEWED AND APPROVED BY SOILS ENGINEER PRIOR TO/DURING PLACEMENT. COMPACTION TO BE IN ACCORDANCE WITH SOILS REPORT DESIGN STANDARDS.
- 10. ALL GRADES SHOWN ON THIS PLAN ARE TO FINISHED GRADE.
- OVERLOT GRADING SHALL BE TO SUBGRADE OF THE BUILDINGS AND ASPHALT PARKING LOT.
- 12. FINAL FINISHED FLOOR ELEVATION SHALL NOT EXCEED MINIMUM FINISHED FLOOR ELEVATION BY MORE THAN TWO (2) FEET.

SU GRADE PREPARATION

ALL FILL PLACED BELOW PAVEMENTS SHOULD BE COMPACTED TO AT LEAST 95 PERCENT OF THE MAXIMUM STANDARD PROCTOR DENSITY WITHIN ±2 PERCENT OF THE OPTIMUM MOISTURE CONTENT. IN CUT AND FILL PLACEMENT OF THE PAVEMENT, THE SUBGRADE SHOULD BE PROOF ROLLED WITH A HEAVY, PNEUMATIC TIRED VEHICLE WHILE BEING OBSERVED BY THE GEOTECHNICAL ENGINEER. AREAS WHICH DEFORM UNDER WHEEL LOADS SHOULD BE REMOVED AND REPLACED.

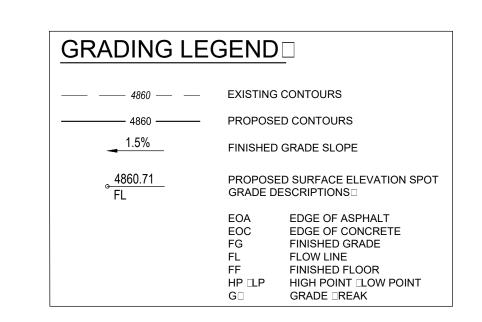

TRANFORMER

– EX. TELE


PROPOSED EASEMENT -

BY SEPARATE DOCUMENT

EXISTING LOT 9 —

ACCESS DRIVE

PEDESTAL

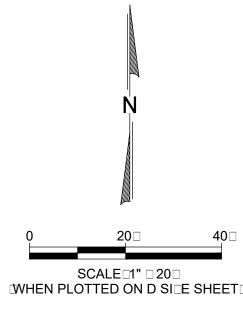

THE CONTRACTOR SHALL LOCATE AND VERIFY ALL EXISTING UTILITY LOCATIONS PRIOR TO CONSTRUCTION






GRADING PLAN
3, AUSTIN INDUSTRIAL F
0 JONES COURT, ERIE, C

DESIGNED □Y□ SDW DRAWN □Y□ $\mathsf{CHECKED} \ \Box \mathsf{Y} \Box$ APPROVED □Y□ JHP PROJECT NO. 197.001

DATE□ 0511012016 AS SHOWN SCALE

SHEET NO. SHEET 4 OF 1

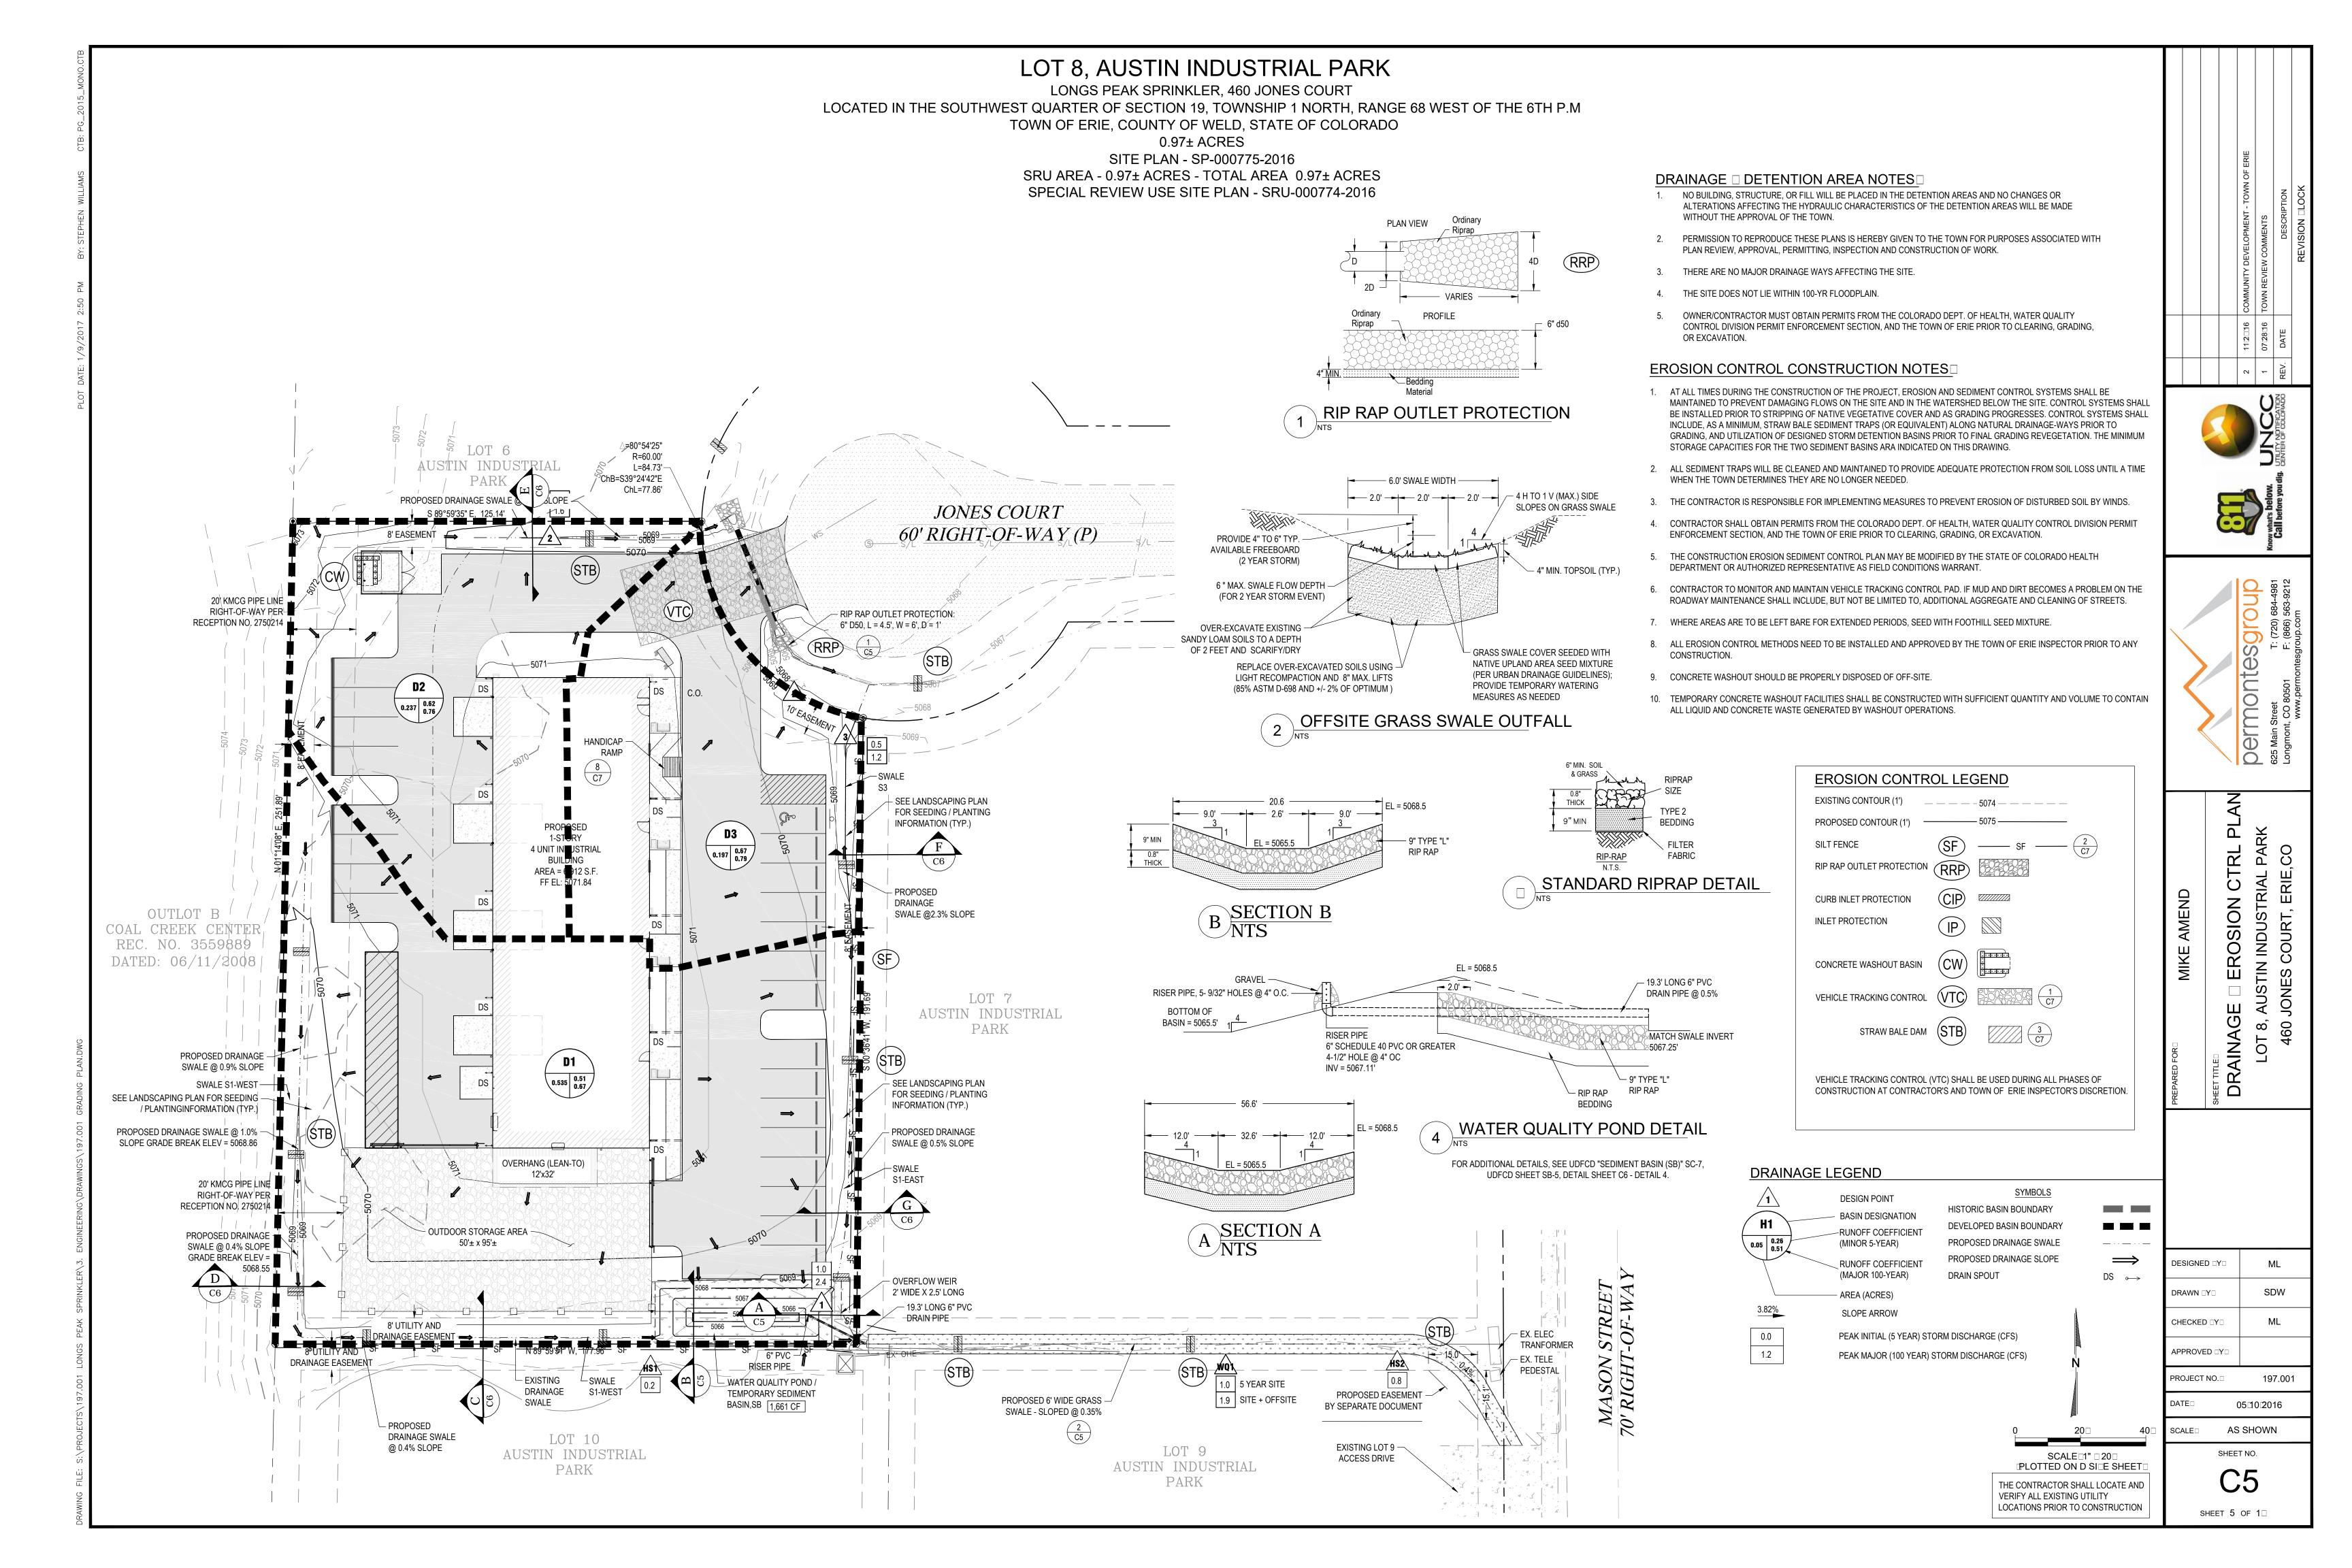

EMERGENCY SPILLWAY ☐ RIPRAP AT FOOT OF ☐ ERM WIDTH OF | DEPTH OF | SPILLWAY THICKNESS VELOCITY BASIN Q100 (cfs) BERM (ft) | SPILLWAY (ft) | SPILLWAY (ft) | INVERT (ft) (fps) SB 2.40 5069.25 5068.75 4.5 13.5 8.0 0.15


DEVELOPED RUNOFF										
SodPoo		Ar□□	I 🗆 🗆 🗆 🗆	TOC	C5	C10	C100	Q5	Q10	Q100
1	D1	0.5□5	56	12	0.51	0.56	0.67	1.0	1.□	2.4
2	D2	0.2□74	68	6	0.62	0.67	0.76	0.7	0.9	1.6
	D□	0.1969	75	9	0.67	0.71	0.79	0.5	0.7	1.2
				-	TOTAL DE	VELOPED	RUNOFF	2.2	2.9	5.2


_			-	-					
	TOTAL DEVELOPED RUNOFF 2.2								
RIP RAP									
PIPE	LOCAT	OCATION LENGTH (ft) WIDT		WIDTH (ft)			VELO	I .	
6" PIPE	SEDIME BASI		1.5	1.5		0.8	1.2	23	
18" PIPE	PIPE DRIVEWAY CULVERT		4.5	4.5		0.8	3.1	l1	


	SWALE CHARACTERISTICS							
Basin	Location	Design Q	Time	Long. Slope	Side Slope	Velocity	Depth	Top Width
#	Name	(cfs)	(min)	%	(h:v)	(fps)	(ft)	(ft)
D1	S1-East	0.5	8.2	0.50	5:1	0.49	0.45	4.5
D1	S1-West	0.5	9.1	0.50	4:1	0.54	0.48	3.8
D2	S2	0.7	2.4	0.50	4:1	0.61	0.52	4.2
D3	S3	0.5	1.3	2.30	6:1	0.87	0.31	3.7
Existing Swale	Offsite	1.9	4.5	0.35	4:1	0.82	0.75	6.0


_						
	WQCV					
	REQL	PROVIDED				
	CU-FT	AC-FT	SB CU-FT			
	1,035	0.024	1,661			
	SEDIMENT BASIN VOLUME					
	REQL	PROVIDED				
	CU-FT	AC-FT	SB CU-FT			


3,488	0.08	1,661				
PROPOSED OFFSITE SWALE CAPACITY (WQ1)						
STUDY POINT	BASIN	Q5 (cfs)				
1	D1	1.0				
WQ1	OFFSITE	0.8				
REQUIRED: 1.8 cfs						
PRO	VIDED 1.9 cf	s				

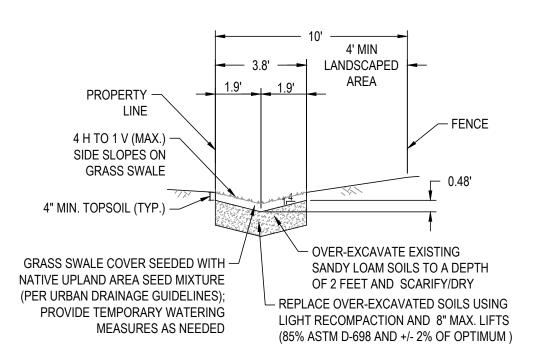


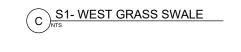

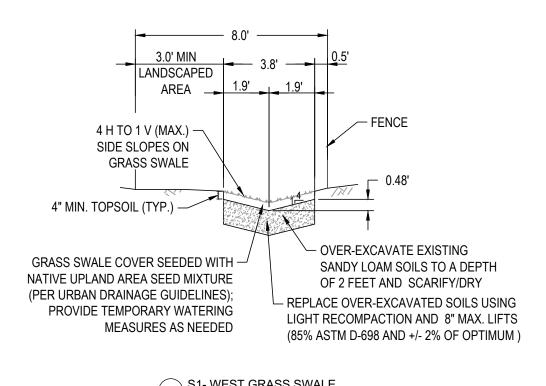

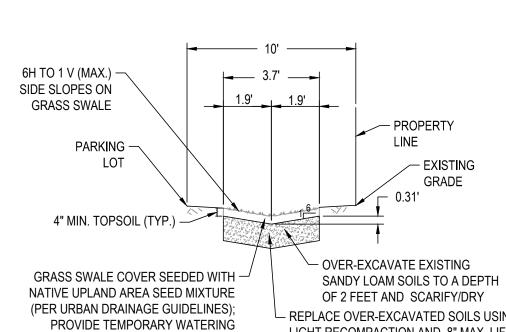

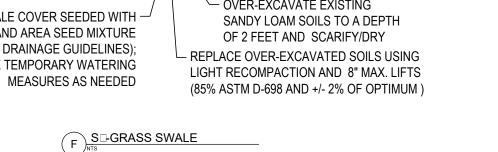

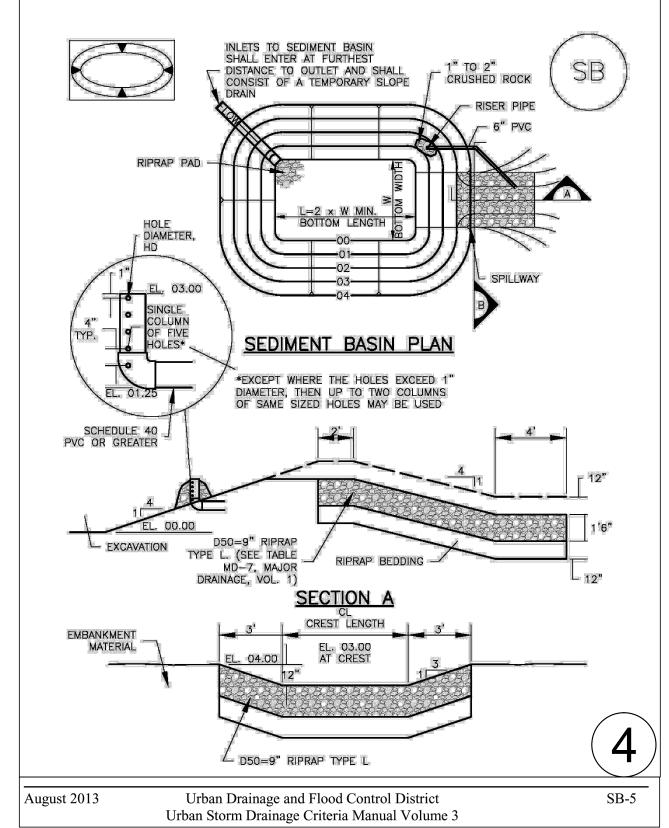

Sediment Basin (SB)

BUILDING -

4 H TO 1 V (MAX.) -

SIDE SLOPES ON

GRASS SWALE

4" MIN. TOPSOIL (TYP.)

GRASS SWALE COVER SEEDED WITH -

NATIVE UPLAND AREA SEED MIXTURE

(PER URBAN DRAINAGE GUIDELINES);

PROVIDE TEMPORARY WATERING

MEASURES AS NEEDED

5H TO 1 V (MAX.) -

SIDE SLOPES ON

GRASS SWALE

GRASS SWALE COVER SEEDED WITH $-\!\!\!\!/$

PROVIDE TEMPORARY WATERING

MEASURES AS NEEDED

G S1- EAST GRASS SWALE

NATIVE UPLAND AREA SEED MIXTURE

(PER URBAN DRAINAGE GUIDELINES);

PARKING -

4" MIN. TOPSOIL (TYP.)

LOT 8, AUSTIN INDUSTRIAL PARK

LONGS PEAK SPRINKLER, 460 JONES COURT

LOCATED IN THE SOUTHWEST QUARTER OF SECTION 19, TOWNSHIP 1 NORTH, RANGE 68 WEST OF THE 6TH P.M.

TOWN OF ERIE, COUNTY OF WELD, STATE OF COLORADO

0.97± ACRES

SITE PLAN - SP-000775-2016

SC-7

SRU AREA - 0.97± ACRES - TOTAL AREA 0.97± ACRES SPECIAL REVIEW USE SITE PLAN - SRU-000774-2016

CONSTRUCTION SEQUENCE FOR EROSION SEDIMENT CONTROL PRACTICES FOR SINGLE LOT

. INSTALL PERIMETER EROSION AND SEDIMENT CONTROLS IDENTIFY THE AREAS WHERE SEDIMENT LADEN RUNOFF COULD LEAVE THE CONSTRUCTION SITE, AND INSTALL PERIMETER CONTROLS TO MINIMIDE THE POTENTIAL FOR OFF-SITE SEDIMENTATION. IT'S IMPORTANT THAT PERIMETER CONTROLS ARE IN PLACE DEFORE ANY LOT EXCAVATION ACTIVITIES □EGIN.

PREFERRED METHODS

• PROTECT DOWN-SLOPE AREAS WITH VEGETATIVE FILTER STRIPS • PROTECT DOWN-SLOPE AREAS WITH SILT FENCES AND OTHER APPROPRIATE PRACTICES • INSTALL STA LE CONSTRUCTION TRAFFIC ENTRANCE

2. PREPARE THE SITE FOR CONSTRUCTION PREPARE THE SITE FOR CONSTRUCTION AND FOR INSTALLATION OF UTILITIES. NOTIFY ALL CONTRACTORS ESPECIALLY THE EXCAVATION CONTRACTOR OF AREAS

TO □E PROTECTED.

PREFERRED METHOD • SALVAGE AND STOCKPILE TOPSOIL OR SU□SOIL

□ □UILD STRUCTURE S□AND CONNECT UTILITIES

CONSTRUCT THE HOME AND CONNECT THE UTILITIES.

4. MAINTAIN CONTROL PRACTICES MAINTAIN ALL EROSION AND SEDIMENT CONTROL PRACTICES UNTIL CONSTRUCTION IS COMPLETED AND THE LOT IS STA□ILI□ED.

5. RE-VEGETATE □UILDING SITE


IMMEDIATELY AFTER ALL OUTSIDE CONSTRUCTION ACTIVITIES ARE COMPLETED, STA ILI E THE LOT WITH SOD, SEED AND OR MULCH.

• REDISTRI □ UTE THE STOCKPILED SU □ SOIL AND TOPSOIL • SEED OR SOD □ARE AREAS

• MULCH NEWLY SEEDED AREAS


6. REMOVE REMAINING TEMPORARY CONTROL MEASURES ONCE THE SOD AND OR VEGETATION IS WELL ESTA LISHED, REMOVE ANY REMAINING

TEMPORARY EROSION AND SEDIMENT CONTROL PRACTICES.

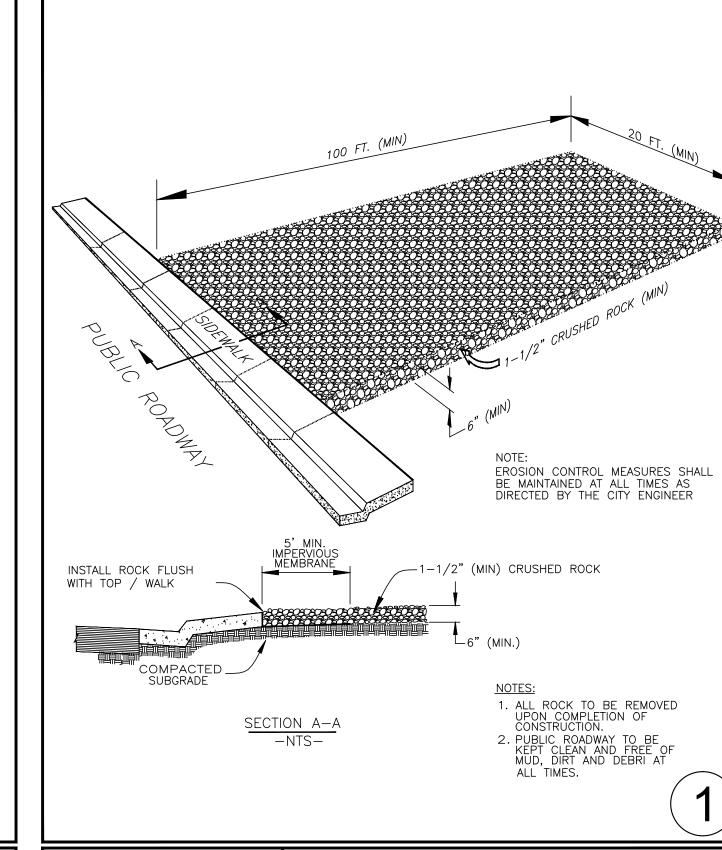






DRAWING TITLE: TRACKING CONTROL PAD DRAWING NUMBER: STM6 DRAWN BY: D. JENKINS APPROVED BY: G. BEHLEN DATE: 06/2004

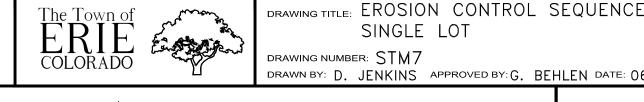



SINGLE LOT DRAWING NUMBER: STM7 DRAWN BY: D. JENKINS APPROVED BY: G. BEHLEN DATE: 06/2004

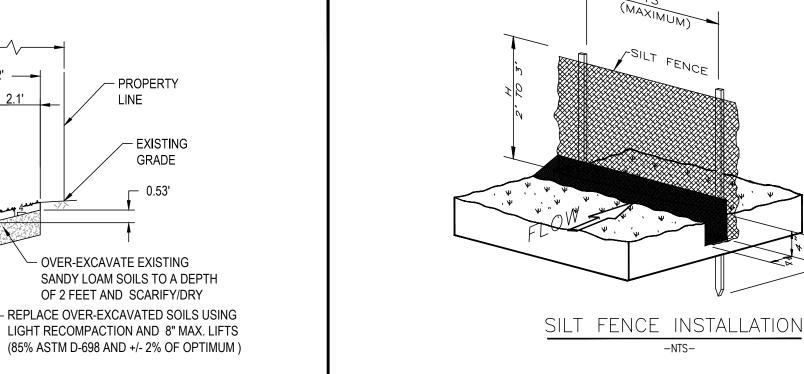

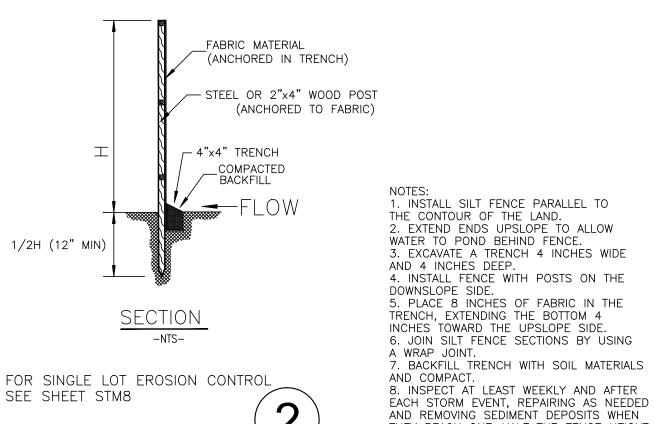

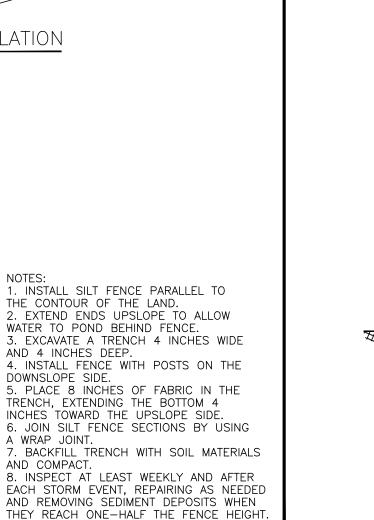

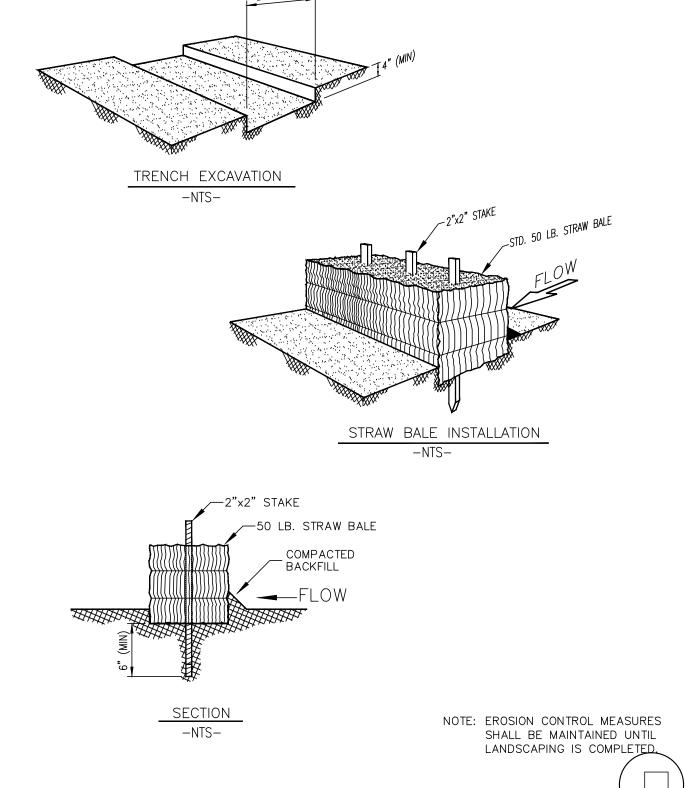

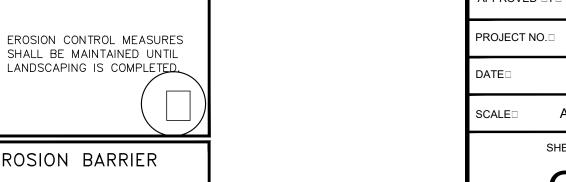

S2-GRASS SWALE 4.5' 2.3' OVER-EXCAVATE EXISTING SANDY LOAM SOILS TO A DEPTH OF 2 FEET AND SCARIFY/DRY REPLACE OVER-EXCAVATED SOILS USING LIGHT RECOMPACTION AND 8" MAX. LIFTS (85% ASTM D-698 AND +/- 2% OF OPTIMUM)

PROPERTY

— EXISTING GRADE

LINE

DRAWN BY: D. JENKINS APPROVED BY: G. BEHLEN DATE: 06/2004

DRAWING TITLE: SILT FENCE EROSION BARRIER DRAWING NUMBER: STM4

DRAWING TITLE: STRAW BALE EROSION BARRIER DRAWING NUMBER: STM5 DRAWN BY: D. JENKINS APPROVED BY: G. BEHLEN DATE: 06/2004

THE CONTRACTOR SHALL LOCATE AND VERIFY ALL EXISTING UTILITY LOCATIONS PRIOR TO CONSTRUCTION

DESIGNED DYD SDW $\mathsf{DRAWN} \; \Box \mathsf{Y} \Box$ ML $\mathsf{CHECKED} \ \Box \mathsf{Y} \Box$ APPROVED DYD 197.001

ermont

CONTROL NOT

AINAGE

MIKE AMEND

0511012016 AS SHOWN

SHEET NO.

SHEET 6 OF 1□

LOT 8, AUSTIN INDUSTRIAL PARK LONGS PEAK SPRINKLER, 460 JONES COURT LOCATED IN THE SOUTHWEST QUARTER OF SECTION 19, TOWNSHIP 1 NORTH, RANGE 68 WEST OF THE 6TH P.M. TOWN OF ERIE, COUNTY OF WELD, STATE OF COLORADO 0.97± ACRES SITE PLAN - SP-000775-2016 SRU AREA - 0.97± ACRES - TOTAL AREA 0.97± ACRES SPECIAL REVIEW USE SITE PLAN - SRU-000774-2016 - SEE DETAIL 1 DETAIL 1 — 1−1/2" Ø DRAIN HOLES NOTE: TOP SECTION ROTATED 90° PLAN VIEW PLAN VIEW * VARIES WITH FLOW NOTES: 1. THE CONCRETE SHALL BE FIBER REINFORCED CONCRETE, WITH A COMPRESSIVE STRENGTH OF 3,000 PSI. MIXING AND PLACING SHALL BE PER THE MANUFACTURER'S RECOMMENDATIONS. WATER TIGHT JOINT (TYP.) -INCLUDING RAMNEK 2-1/2" 44 44 44 4 3" CLEARANCE ———— SECTION A SECTION B SIDE VIEW DRAWING TITLE: FLOW METERING AND SAMPLING DRAWING TITLE: CONCRETE BASE FOR METER PIT STATION DRAWING NUMBER: W14B (2 OF 2) DRAWING NUMBER: SS2 DRAWN BY: D. JENKINS APPROVED BY: G. BEHLEN DATE: 06/2004 DRAWN BY: D. JENKINS APPROVED BY: G. BEHLEN DATE: 01/2009 - RECESSED CAST IRON CAP TYPE LID WITH 1-7/8" DIA HOLE FORD W3-T. INSTALL LID AT 2" MIN, 4" MAX ABOVE BACK OF CURB OR SIDEWALK FORGED BRASS PENTAGON BOLT-MIKE AMEND MAX ABOVE BACK OF CURB OR SIDEWALK 1. AVOID PLACING DRAINAGE STRUCTURES, TRAFFIC SIGNAL EQUIPMENT, OR OTHER OBSTRUCTIONS IN FRONT OF RAMP ACCESS AREAS — DISHED FROST PROOF METER LID— ARMORCAST 12" DIAMETER 2. RAMP SLOPES SHALL NOT BE STEEPER THAN 12:1. THE DETECTABLE WARNING AND WELL AREA SLOPES SHALL NOT BE STEEPER THAN 20:1. 4'MIN. 4' MIN. 3. GROOVED JOINTS SHALL BE SPACED 8" APART → METER PIT LOCKING SCREW 1/2" DEPTH. FOR CLARITY, NOT ALL JOINTS RING CAST IRON 1. FOR INSTALLATION IN ROADWAYS,DRIVEWAYS, SIDEWALKS, OR PARKING AREAS PRIOR APPROVAL REQUIRED. ARE SHOWN. NO LIP AT FLOW LINE. 4. THE RAMP AREA SHALL RECEIVE A COARSER BRUSH TREATMENT THAN THE SIDEWALK, BROOMING SHALL NOT CAUSE THE GROOVES TO CLOSE. 5. DETECTABLE WARNINGS SHALL BE EAST JORDON 2. POLYMER CONCRETE RING & LID ALLOWABLE. IRON WORKS 7005 SERIES DETECTABLE WARNING PLATES OR APPROVED EQUAL. . METER PIT SHALL BE CONSTRUCTED OF MODIFIED POLYETHYLENE WITH MINIMUM WALL THICKNESS OF 0.50" SIDEWALK RAMP TYPE 1A 4. EXTENSIONS AND OFF GRADE EXTENSIONS SHALL BE INSERTED BETWEEN THE DOME AND TOP RING TO PUT LID TO GRADE. 5. NO CONNECTIONS OR CHANGES IN PIPE DIAMETER SHALL BE MADE IN THE METER 5'-0" MIN. 4'MIN. NO CONNECTIONS SIDEWALK PIT OR IN THE DISTANCE OF FIVE FEET BEYOND THE METER. PIT WALL ON THE OUTLET PAVEMENT DESIGNED □Y□ 6. LAWN SPRINKLER CONNECTIONS SHALL BE A MINIMUM OF FIVE FEET FROM THE METER PIT WALL ON THE OUTLET SIDE. CONCRETE SIDEWALK DRAWN □Y□ DETECTABLE WARNING CHECKED $\Box Y \Box$ AND WELL DRAIN HOLE -DETAIL, SHEET 16A APPROVED DYD SECTION A-A CONCRETE BASE IS OPTIONAL. IF NOT USED, INSTALL 12" DEPTH OF 3/4" - 1" WASHED ROCK PROJECT NO.□ METER SIZE LAYING LENGTH 5/8"x 3/4" 7-1/2" $\mathsf{DATE}\,\square$ 3/4" SCALE□ 1" 10-3/4" ISOMETRIC VIEW DRAWING TITLE: OUTSIDE SETTING FOR DRAWING TITLE: CURB RAMP TYPE 1 5/8" x 3/4", 3/4" & 1" METER ATTACHED WALK DRAWING NUMBER: W14A (1 OF 2) DRAWN BY: D. JENKINS APPROVED BY: G. BEHLEN DATE: 06/2004 DRAWING NUMBER: SW5 DRAWN BY: C. GERATY APPROVED BY: G. BEHLEN DATE: 04/2016

AILS - CIVIL DETAILS I 8, AUSTIN INDUSTRIAL PARK 0 JONES COURT, ERIE, CO

DETAILS -LOT 8, AUST 460 JONE

SDW

 ML

197.001

4282016

AS SHOWN

SHEET NO.

SHEET 7 OF 1□

JONES COURT

60' RIGHT-OF-WAY (P)

LOT 7 AUSTIN INDUSTRIAL PARK

2"X2" SQUARE TUBE

.095 WALL THICKNESS

- SEEDED AREA

QUALITY POND)

(WATER

AUSTIN INDUSTRIAL

PLANTER BOX -& SITTING BENCH

PLANTER BOX — & SITTING BENCH

PLANTER BOX -

PLANTER BOX -& SITTING BENCH

OVERHANG (LEAN-TO) 12'x32'

LOT 10

AUSTIN INDUSTRIAL

PARK

OUTDOOR STORAGE AREA $50' \pm x 95' \pm$

- EDGE OF VEGETATION

LANDSCAPE EDGING

EXISTING -

& SITTING BENCH

BOULDERS

20' KMCG PIPE LINĘ

ALL TREES TO BE LOCATED 10' AWAY

FROM GAS LINE MINIMUM

OUTLOT B

COAL CREEK CENTER

REC. NO. 3559889

DATED: 06/11/2008

20' KMCG PIPE LINE RIGHT-OF-WAY PER RECEPTION NO. 2750214

> 8' UTILITY AND DRAINAGE EASEMENT

14-DAW -

RIGHT-OF-WAY PER RECEPTION NO. 275021

- 1. ALL PLANTS ARE SHOWN AT APPROXIMATELY 75% MATURE SIZE.
- 2. AL PROPOSED CONTOURS ARE INDICATED ON LANDSCAPE PLAN @ 1' INTERVALS. NO GRADES EXCEED 3:1.
- 3. ALL EXISTING TREES AND SHRUBS SHALL BE PROTECTED DURING CONSTRUCTION PER TOWN OF ERIE STANDARDS AND SPECIFICATIONS SEC. 102.
- 4. ALL PLANT MATERIALS SHALL MEET THE SPECIFICATIONS OF THE AMERICAN ASSOCIATION OF NUSERYMEN (AAN) FOR NUMBER ONE GRADE AND SHALL WIRE, TWINE, BURLAP, AND OR OTHER CONTAINMENT MATERIAL REMOVED FROM ROOT BAL AND TRUNK PRIOR TO PLANTING.
- 5. MINOR CHANGES IN SPECIES AND PLANT LOCATIONS MAY BE MADE AT THE TIME OF CONSTRUCTION DUE TO MATERIAL AVAILABILITY AND/ OR SITE CONDITIONS, QUALITY AND
- 6. TREES SHALL NOT BE PLANTED WITHIN 10' OF ANY SEWER, WATER OR GAS LINE. TREE PLANTING SHALL BE COORDINATED WITH XCEL ENERGY. LOCATION OF ALL UTILITIES SHALL BE VERIFIED IN
- THER EROSION. SUBGRADE WORK TO ALLOW A MINIMUM 6" DEPTH OF TOPSOIL. SUBGRADE TO BE SCARIFIED TO A MINIMUM DEPTH OF 6" AND TOPSOIL. AND SOIL AMENDMENTS AS SPECIFIED HEREIN, SHALL BE THOROUGHLY BLENDED WITH THE LANDSCAPED AND REVEGETATED AREAS AT A RATE OF AT LEAST FIVE (5) CUBIC YARDS PER 1,0000 SQ. FT. OF LANDSCAPED AREA AND THREE (3) CUBIC YARDS PER 1,000 SQ. FT. OF REVEGETATED NATIVE AREA. INCREASE AMOUNT OF ORGANIC AMENDMENTS IF NEEDED PER SOILS TESTS. ORGANIC SOIL AMENDMENTS TO BE CERTIFIED AS CLASS 1 COMPOST' PER TOE-S&S SEC. 1022.01.
- COVERS SHALL BE MULCHED WITH SHREDDED BARK TO A MINIMUM DEPTH OF 3" OVER PERMEABLE WEED BARRIER FABRIC. TREE PLANTING RINGS TO LIKEWISE RECEIVE SHREDDED BARK MULCH AS ABOVE. MULCH TO BE SEPARATED FROM SOD AND DRYLAND GRASS AREAS WITH 3/16"x6" GREEN COLORED STEEL EDGER.
- SCHEDULE AT LEFT OF EITHER THE DRILLED SEEDING METHOD AS SPECIFIED IN TOE-S&S SEC. 1033.01.02 2500 lbs./ACRE OF VIRGIN WOOD CELLULOSE FIBER. HYDRO-MULCHED INCLUDING 150
- AREAS WILL BE COVERED BY SPRAY HEADS: DRYLAND GRASSES WILL HAVE A TEMPORARY IRRIGATION SYSTEM TO ESTABLISH GROWTH. THE IRRIGATION SYSTEM SHALL BE INSTALLED WILL INCORPORATE IRRIGATION MEASURES AND SCHEDULING THAT PROVIDE FOR WATER CONSERVATION. IRRIGATION PLANS WILL BE SUBMITTED BY A LANDSCAPE CONTRACTOR TO THE TOWN OF ERIE FOR REVIEW AND APPROVAL PRIOR TO ISSUANCE OF A BUILDING PERMIT.
- 11. ALL TREES SHALL BE STAKED FOR ONE YEAR AND STAKES REMOVED AFTER THE YEAR IS OVER.
- 12. REQUIREMENTS OF THE TOWN OF ERIE STANDARDS AND SPECIFICATIONS FOR LANDSCAPE INSTALLATION AND MAINTENANCE SHALL BE ADHERED TO. AS-BUILT DRAWINGS SHALL BE PROVIDED TO THE TOWN PER TOE S&S SEC. 222.00 (CONSTRUCTION ACCEPTANCE PROCEDURE).
- 13. IF TRANSFORMERS, GROUND MOUNTED HVAC EQUIPMENT, UTILITY PEDESTALS, ETC. ARE NOT SHOWN ON THE SITE IMPROVEMENT PLAN, ADDITIONAL LANDSCAPING/SCREENING MAY BE REQUIRED BASED ON FIELD CONDITIONS DISCOVERED VIA THE SITE INSPECTION BY STAFF, MADE PRIOR TO THE ISSUANCE OF THE CERTIFICATE OF OCCUPANCY, OR FINAL INSPECTION AS APPLICABLE.
- 14. THE ARCHITECT SHALL INSPECT AND SIGN-OFF ON INSTALLATION OF ALL TREES, SHRUBS, SEEDING AND IRRIGATION.

DESIGN INTENT

THIS LANDSCAPE PLAN FOLLOWS THE EXISTING CONCEPTS OF THE SURROUNDING PROPERTIES. PROPOSED PLANT MATERIALS SUPPORT LOW WATER USE AND EASE OF MAINTENANCE. PROPOSED SHRUBS AND GRASSES WILL PROVIDE YEAR ROUND INTEREST AND THE PLANTS SELECTED ARE APPROPRIATE FOR THE WATER AVAILABILITY AND CLIMATE OF NORTHERN COLORADO. THE PROPOSED IRRIGATION SYSTEM WILL MINIMIZE EXCESS RUNOFF THROUGH UTILIZING DRIP IRRIGATION, TIMING, AUTOMATIC SHUTOFFS, AND RAIN SENSORS.


GROUND COVER LANDSCAPE

1	IRRIGATED TURF:	287 SF
4	MULCH BED WITH DRIPLINE:	6,242 SF
	TOTAL	6,529 SF

GROUND COVER INON-LANDSCAPE

	TOTAL	13,045 SF
5	SEEDED IN WATER QUALITY POND:	1,326 SF
3	CRUSHED ASPHALT OR CRUSHED STONE:	5,300 SF
2	NATIVE SEED NATIVE SEED-R.O.W.	5,514 SF 905 SF



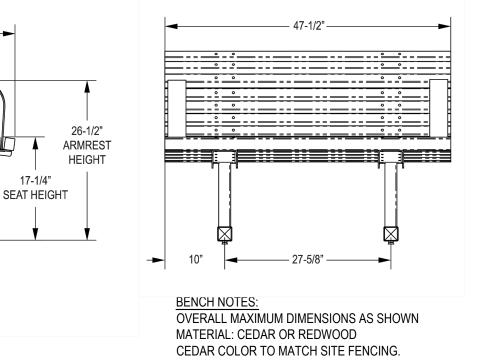



WOODEN PLANTER BOX NOTES:

OVERALL MAXIMUM DIMENSIONS - 16" HIGH x 32" WIDE x18" DEEP INSIDE MAXIMUM DIMENSIONS - 12" HIGH x 30" WIDE x 16" DEEP MATERIAL: CEDAR OR REDWOOD CEDAR COLOR TO MATCH SITE FENCING.







THE CONTRACTOR SHALL LOCATE AND VERIFY ALL EXISTING UTILITY

LOCATIONS PRIOR TO CONSTRUCTION

SHEET 8 OF 1

DESIGNED □Y□ SDW $\mathsf{DRAWN} \; \Box \mathsf{Y} \Box$ $\mathsf{CHECKED} \ \Box \mathsf{Y} \Box$ JHP APPROVED DYD 197.001

PROJECT NO. 0511012016 AS SHOWN SCALE

SHEET NO.

LOT 8, AUSTIN INDUSTRIAL PARK

LONGS PEAK SPRINKLER, 460 JONES COURT

LOCATED IN THE SOUTHWEST QUARTER OF SECTION 19, TOWNSHIP 1 NORTH, RANGE 68 WEST OF THE 6TH P.M. TOWN OF ERIE, COUNTY OF WELD, STATE OF COLORADO

0.97± ACRES

SITE PLAN - SP-000775-2016 SRU AREA - 0.97± ACRES - TOTAL AREA 0.97± ACRES SPECIAL REVIEW USE SITE PLAN - SRU-000774-2016

SYMBOL	ABBREVIATION	QUANTITY	COMMON/ BOTANICAL NAME	PLANTING	APPROX.	COMMENTS
			DECIDUOUS TREES	SIZE	FULL GROWTH	
			EASTERN REDBUD			
	ER	1	CERCIS CANADENSIS	2" GAL-B&B	30'Hx20'S	OPEN SPACE TREES
+ }	RMM	1	ROCKY MOUNTAIN MAPLE ACER GLOBRUM	2" GAL-B&B	20'Hx15'S	OPEN SPACE TREES
	FM	2	FREEMAN MAPLE ACER X FREEMANII	2" GAL-B&B	75'Hx45'S	OPEN SPACE TREES
	SS	2	SHADBLOW SERVICEBERRY AMELANCHIER CANADENSIS	2" GAL-B&B	30'Hx20'S	OPEN SPACE TREES
			ORNAMENTAL TREES			
	MHA	1	MONROVIA'S HONEYCRISP APPLE MALUS HONEYCRISP	2" GAL-B&B	25'Hx20'S	STREET BUFFER TREES
	RMA	1	RED MCINTOSH APPLE MALUS MCINTOSH	2" GAL-B&B	25'Hx20'S	OPEN SPACE TREES
	GDA	1	'MULLINS' STARK GOLDEN DELICIOUS MALUS YELLOW DELICIOUS	2" GAL-B&B	25'Hx20'S	OPEN SPACE TREES
	PC	3	PROFUSION CRABAPPLE MALUS PROFUSION RADIANT	2" GAL-B&B	30'Hx20'S	OPEN SPACE TREES
	SSC	2	'SPRING SNOW' CRABAPPLE MALUS SPRING SNOW	2" GAL-B&B	30'Hx20'S	OPEN SPACE TREES
	NLC	3	NARROWLEAF COTTONWOOD POPULUS ANGUSTIFOLIA	2" GAL-B&B	40'Hx30'S	OPEN SPACE TREES
,000,			EVERGREEN TREES			
33 - 4 - 4 - 4 - 4 - 4 - 4 - 4 - 4 - 4 -	CBS	5	COLORADO BLUE SPRUCE PICEA PUNGENS GLAUCA	6-8 FT. TALL	50'Hx 20'S	
	AP	1	AUSTRIAN PINE PINUS NIGRA	4-6 FT. TALL	50'Hx 30'S	
7 -		23	TOTAL TREES			
			SHRUBS			
+	BMS	5	"BLUE MIST" SPIREA (FLOWERING) CARYOPTERIS X CLANDONENSIS	5 GAL	3'H X 3'S	
	RTG	5	RED TWIG DOGWOOD CORNUS SERICEA	5 GAL	4'H X 4'S	
	JS	3	JAPANESE SPIREA SPIREA JAPONICA	5 GAL	3'H X 3'S	
	PSC	10	PURPLELEAF SANDCHERRY PRUNIS CISTERNA	5 GAL	4'H X 4'S	
	DAW	31	DWARF ARCTIC WILLOW SALIX PURPUREA	5 GAL	4'H X 4'S	
	LIL	10	COMMON LILAC SYRINGA VULGARIS	5 GAL	4'H X 4'S	
	SGJ	10	SEA OF GOLD JUNIPER JUNIPERUS X MEDIA	5 GAL	4'H X 4'S	
	SJ	8	SAVIN JUNIPER JUNIPERUS SABRINA	5 GAL	1'H X 8'S	
	MP	18	MUGO PINE PINUS MUGO	5 GAL	3'H X 6'S	
		86	TOTAL SHRUBS			
Г			ORNAMENTAL GRASSES	T		
*	FR	20	FEATHER REED/ KARL FORSTER CALAMAGROSTIS × ACUTIFLORA 'KARL FORSTER'	1 GAL	3'H X 2'S	
	PP	10	PAMPAS CORTADERIA SELLOANA	1 GAL	8'H X 1'S	
muraining	BF	25	BLUE FESCUE FESTUCA GLAUCA 'ELIJAH BLUE'	1 GAL	2'H X 1'S	
	MG	10	MAIDEN GRASS MISCANTHUS	1 GAL	2'H X 1'S	
		65	TOTAL GRASSES			

LANDSCAPING SHALL BE PLANTED AND MAINTAINED IN A NEAT, CLEAN AND HEALTHY CONDITION BY THE OWNER. THIS SHALL INCLUDE PROPER PRUNING, MOWING AND AERATION OF LAWNS, REPLACEMENT OF MULCH, WEEDING, REMOVAL OF LITTER AND THE REGULAR WATERING OF ALL PLANTINGS. IRRIGATION SHALL BE MAINTAINED TO MAXIMIZE WATER CONSUMPTION. SHOULD ANY PLANT MATERIAL DIE, THE OWNER, SUCCESSOR, OR ASSIGNS SHALL BE RESPONSIBLE FOR THE REPLACEMENT OF PLANT(S) WITHIN ONE PLANTING SEASON. REPLACEMENT OF PLANT MATERIALS SHALL OCCUR AT THE FOLLOWING RATE.


TWO	PLANT REPLACEMENT WITHIN						
TTPE	1 YEAR	2+ YEARS					
Tree – Deciduous	Increase caliper by 1"	Increase caliper by 1.5"					
Tree - Coniferous	Increase height by 1.5°	Increase height by 2'					
Shrub	Replace with plants of at least ½ mature size	Replace with plants of at least ½ matur size					


MIXED GRASS PRAIRIE NATIVE SEED MIXTURE: FOR USE IN OPEN SPACE NATIVE SEEDING AT LEAST 10 FEET AWAY FROM ROAD AND TRAIL


COMMON NAME	SCIENTIFIC NAME	VARIETY	OZ/ACRE	PLS LBS/ACRE
BUFFALO GRASS	BUCHLOE DACTYLIODES	NATIVE		3
SIDEOATS GRAMA	BOUTELUA CURTIPENDULA	BUITE		5
PRAIRIE SANDREED	CALAMOVILFA LONGIFOLIA	GOSHEN		1
BLUE GRAMA	CHONDROSUM GRACILE	LOVINGTON		3
WESTERN WHEATGRASS	PASCOPYRUM SMITHII	ARRIBA		5
LITTLE BLUESTEM	SCHIZACHRYTUM SCOPARIUM	PASTURA		4
ALKALI SACATON	SPOROBOLUS AIROIDES	COMMON		1
SAND DROPSEED	SPOROBOLUS CRYPTANDRUS	COMMON		1
SWITCHGRASS	PANICUM VIRGATUM	BLACKWELL		5
FRINGED SAGE*	ARTEMISIA FRIGIDA	COMMON	1	
PURPLE PRAIRIE CLOVER*	DALEA PURPUREA	COMMON	6	
BLANKETFLOWER*	GAILLARDIA ARISTATA	COMMON	6	
GAYFEATHER*	LIATRIS PUNCTATA	COMMON	4	
COMMON NAME	SCIENTIFIC NAME	VARIETY	OZ/ACRE	PLS LBS/ACRE
BLUE FLAX*	LINUM PERENNE	COMMON	3	
TANSY ASTER*	MACHAERANTHERA TANACETAFOLIA	COMMON	3	
PRAIRIE CONEFLOWER*	RATIBIDA COLUMNIFERA	COMMON	3	
OUNCES	d 6		26	1.625
SEEDING RATE POU	IDC DI S/ACDT			29,625

TA LE OF LANDSCAPING REQUIREMENTS

REQUIREMENT REFERENCE	REQUIREMENT	QUANTITY	LANDSCAPE AREA REQUIRED	LANDSCAPE AREA PROVIDED	TREES REQUIRED	TREES PROVIDED	SHRUBS REQUIRED	SHRUBS PROVIDED
SECTION 10-6-4 E 1.a	1 TREE PER 40 LF OF STREET FRONTAGE	84 LF			2	2		
SECTION 10-6-4 E 7.b	15% GROSS SITE AREA LANDSCAPED	42,200 SF	6,330 SF	6,529 SF				
SECTION 10-6-4 E 7.c.1	1 TREE PER 1000 SF OF LS AREA OUTSIDE PARKING AND R.O.W. REQUIREMENT	6,529 SF			7	8		
SECTION 10-6-4 E 7.c.8	1 SHRUB PER 150 SF OF LS AREA OUTSIDE PARKING AND R.O.W. REQUIREMENT	6,529 SF					44	58
SECTION 10-6-4 G 10	1 TREE PER 150 SF OF SCREENING AREA	1,120SF			7	4	30	30
SECTION 10-6-4 E 8.e.1	1 TREE PER 15 PARKING SPACES	23			2	7		
SECTION 10-6-4 E 8.e.8	1 SHRUB PER PARKING SPACES	23					23	57
SECTION 10-6-2 C 6	1.5 TIMES THE CALIBER SIZE OF TREE BEING REMOVED W/ TREES OF MINIM 2" CALIBER	0						
	OTE: IN THE EVENT OF A DISCREPANCY BETWEEN THE PAN GRAPHIC AND THE LANDSCAPE LEGEND, THE PLANT MATERIAL QUANTITY S DETERMINED BY THE PLAN GRAPHIC SHALL TAKE PRECEDENCE.				11	21	95	145

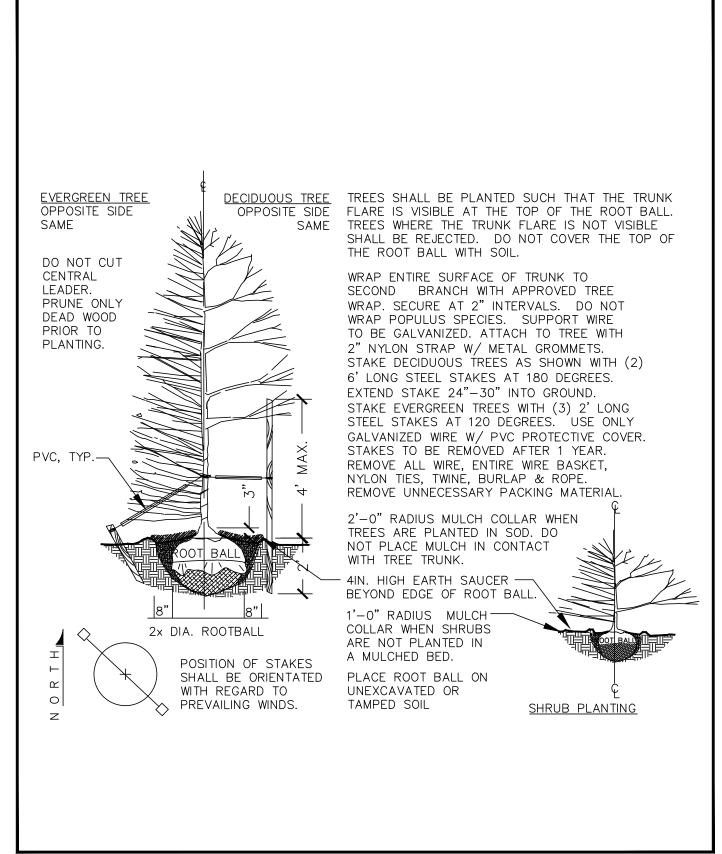

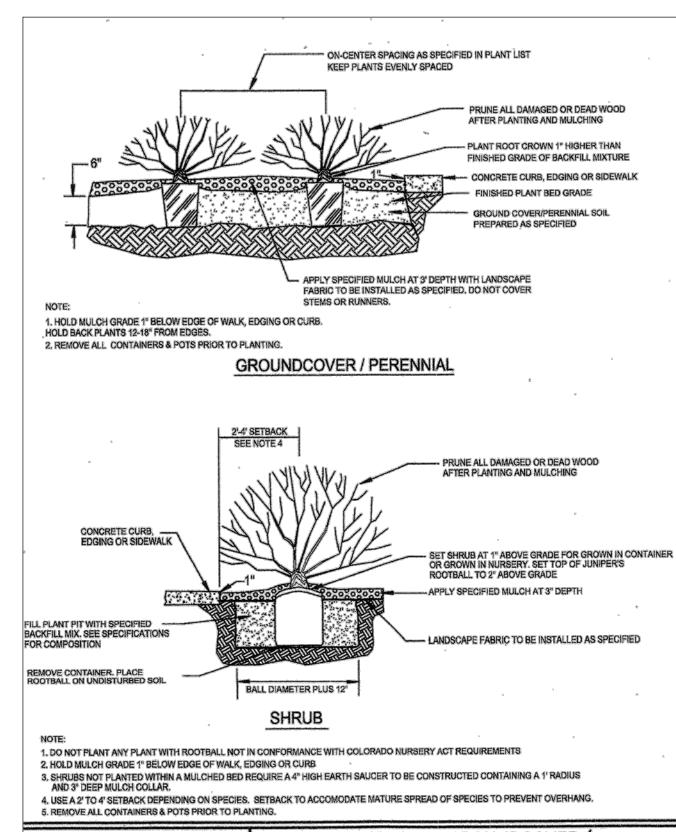

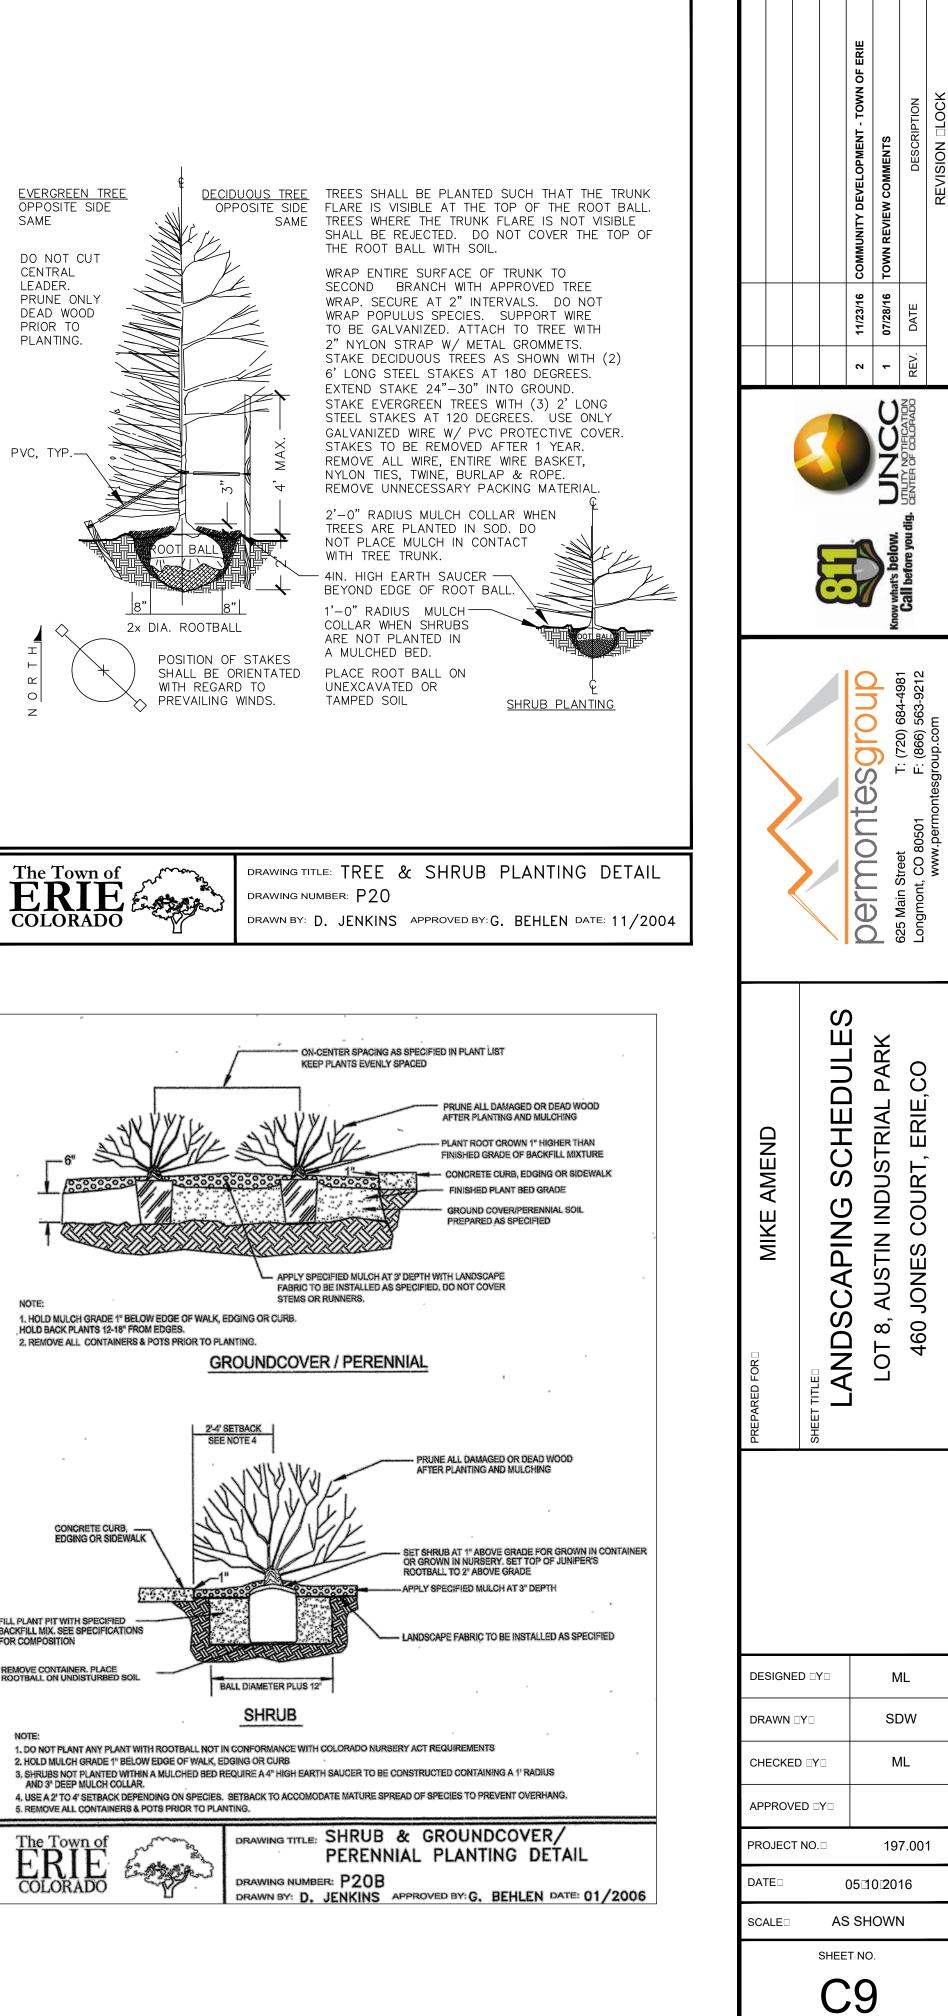

SHEET 9 OF 1□

LOT 8, AUSTIN INDUSTRIAL PARK

LONGS PEAK SPRINKLER, 460 JONES COURT

LOCATED IN THE SOUTHWEST QUARTER OF SECTION 19, TOWNSHIP 1 NORTH, RANGE 68 WEST OF THE 6TH P.M.


TOWN OF ERIE, COUNTY OF WELD, STATE OF COLORADO


 $0.97 \pm ACRES$


SITE PLAN - SP-000775-2016

SRU AREA - 0.97 ± ACRES - TOTAL AREA 0.97 ± ACRES


SPECIAL REVIEW USE SITE PLAN - SRU-000774-2016

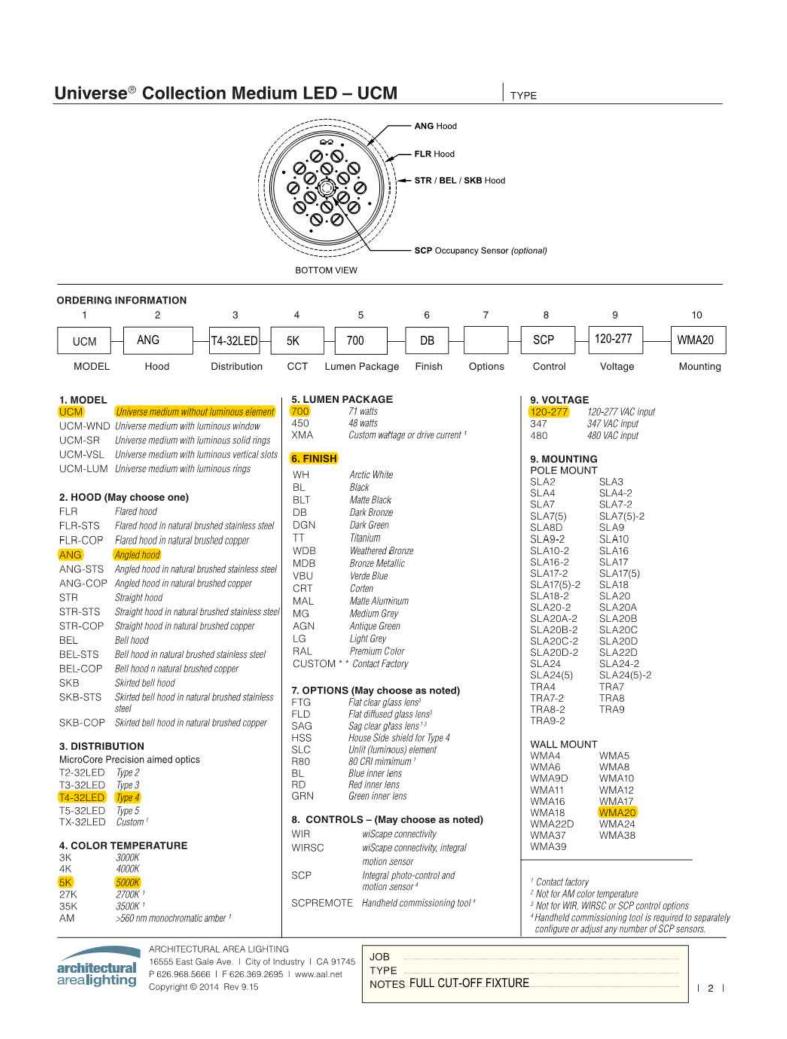

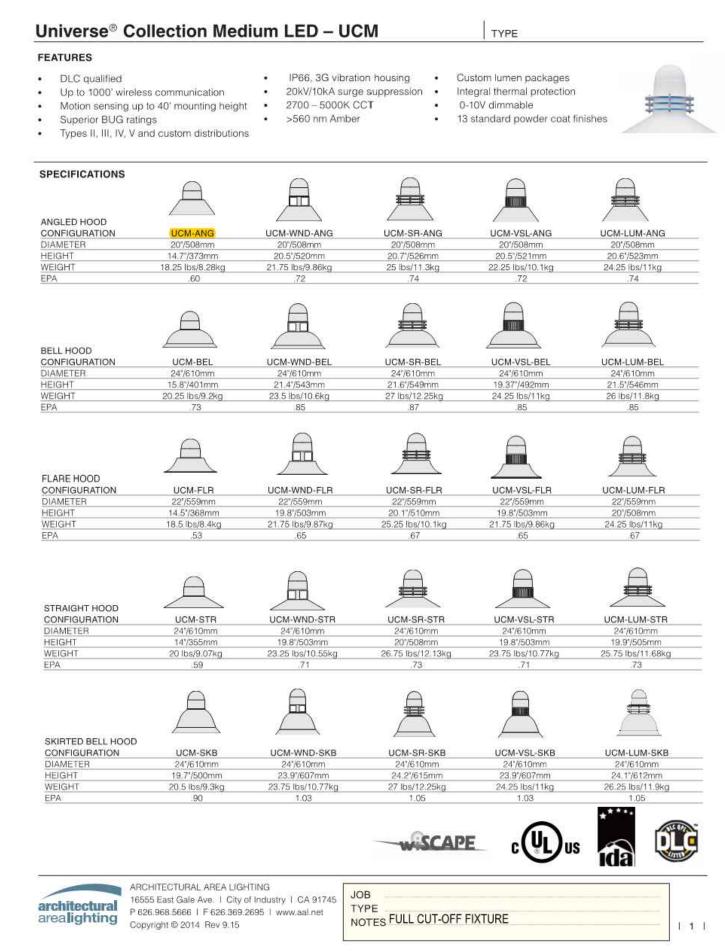

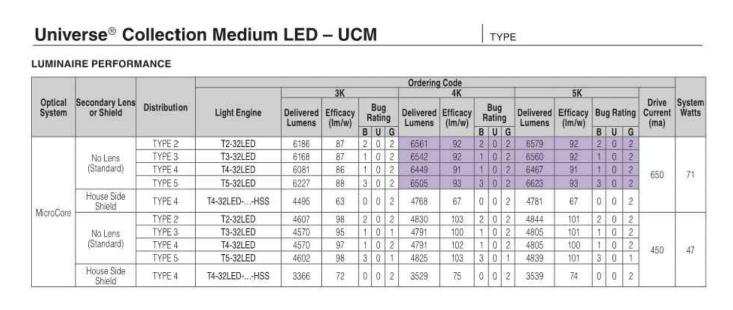



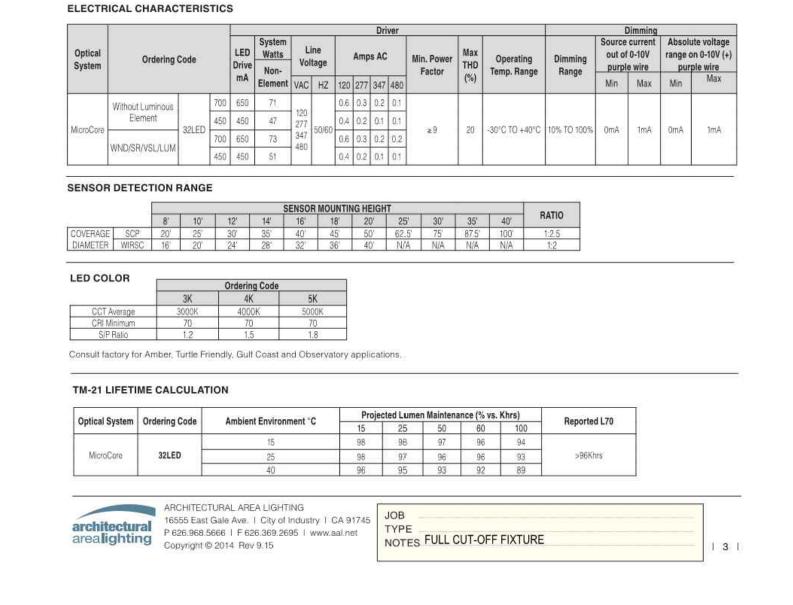

Luminaire Schedule


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Calculation Summary

Ground_Planar

1.67 6.5

0.0



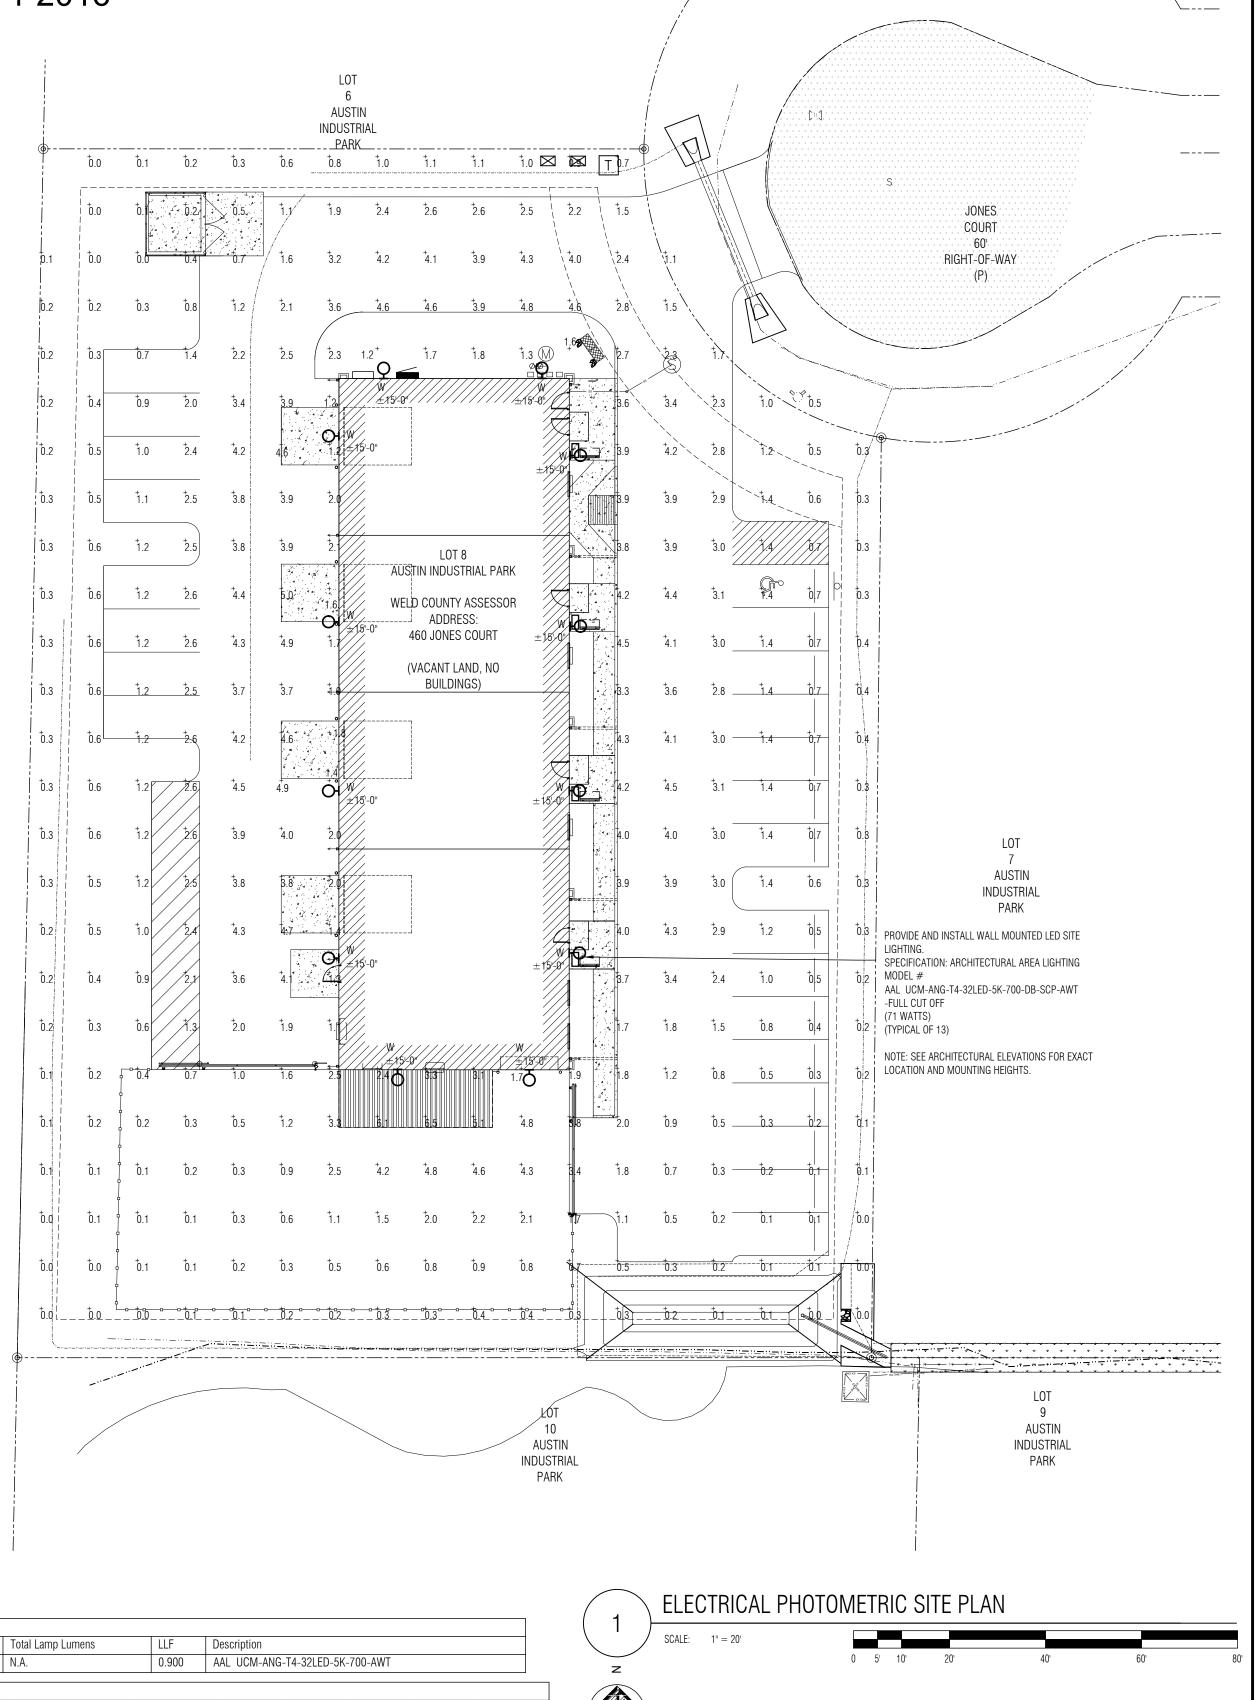

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SUBMITTED FOR:

NO. DATE DESCRIPTION PER TOWN COMMENTS 11-23-2016

> SPRINKL PEAK

JONES COURT

COLORADO

ER

DRN: C3S CKD: MDC/JMM


SHEET TITLE: ELECTRICAL SITE PHOTOMETRIC

SCALE: As Noted SHEET NUMBER: SHEET 10 of 13

LOT 8, AUSTIN INDUSTRIAL PARK

LONGS PEAK SPRINKLER, 460 JONES COURT
LOCATED IN THE SOUTHWEST QUARTER OF SECTION 19, TOWNSHIP 1 NORTH, RANGE 68 WEST OF THE 6TH P.M. TOWN OF ERIE, COUNTY OF WELD, STATE OF COLORADO 0.97± ACRES

SITE PLAN - SP - 000775-2016 SRU AREA - 0.97 ± ACRES - TOTAL AREA 0.97 ± ACRES SPECIAL REVIEW USE SITE PLAN - SRU-000774-2016

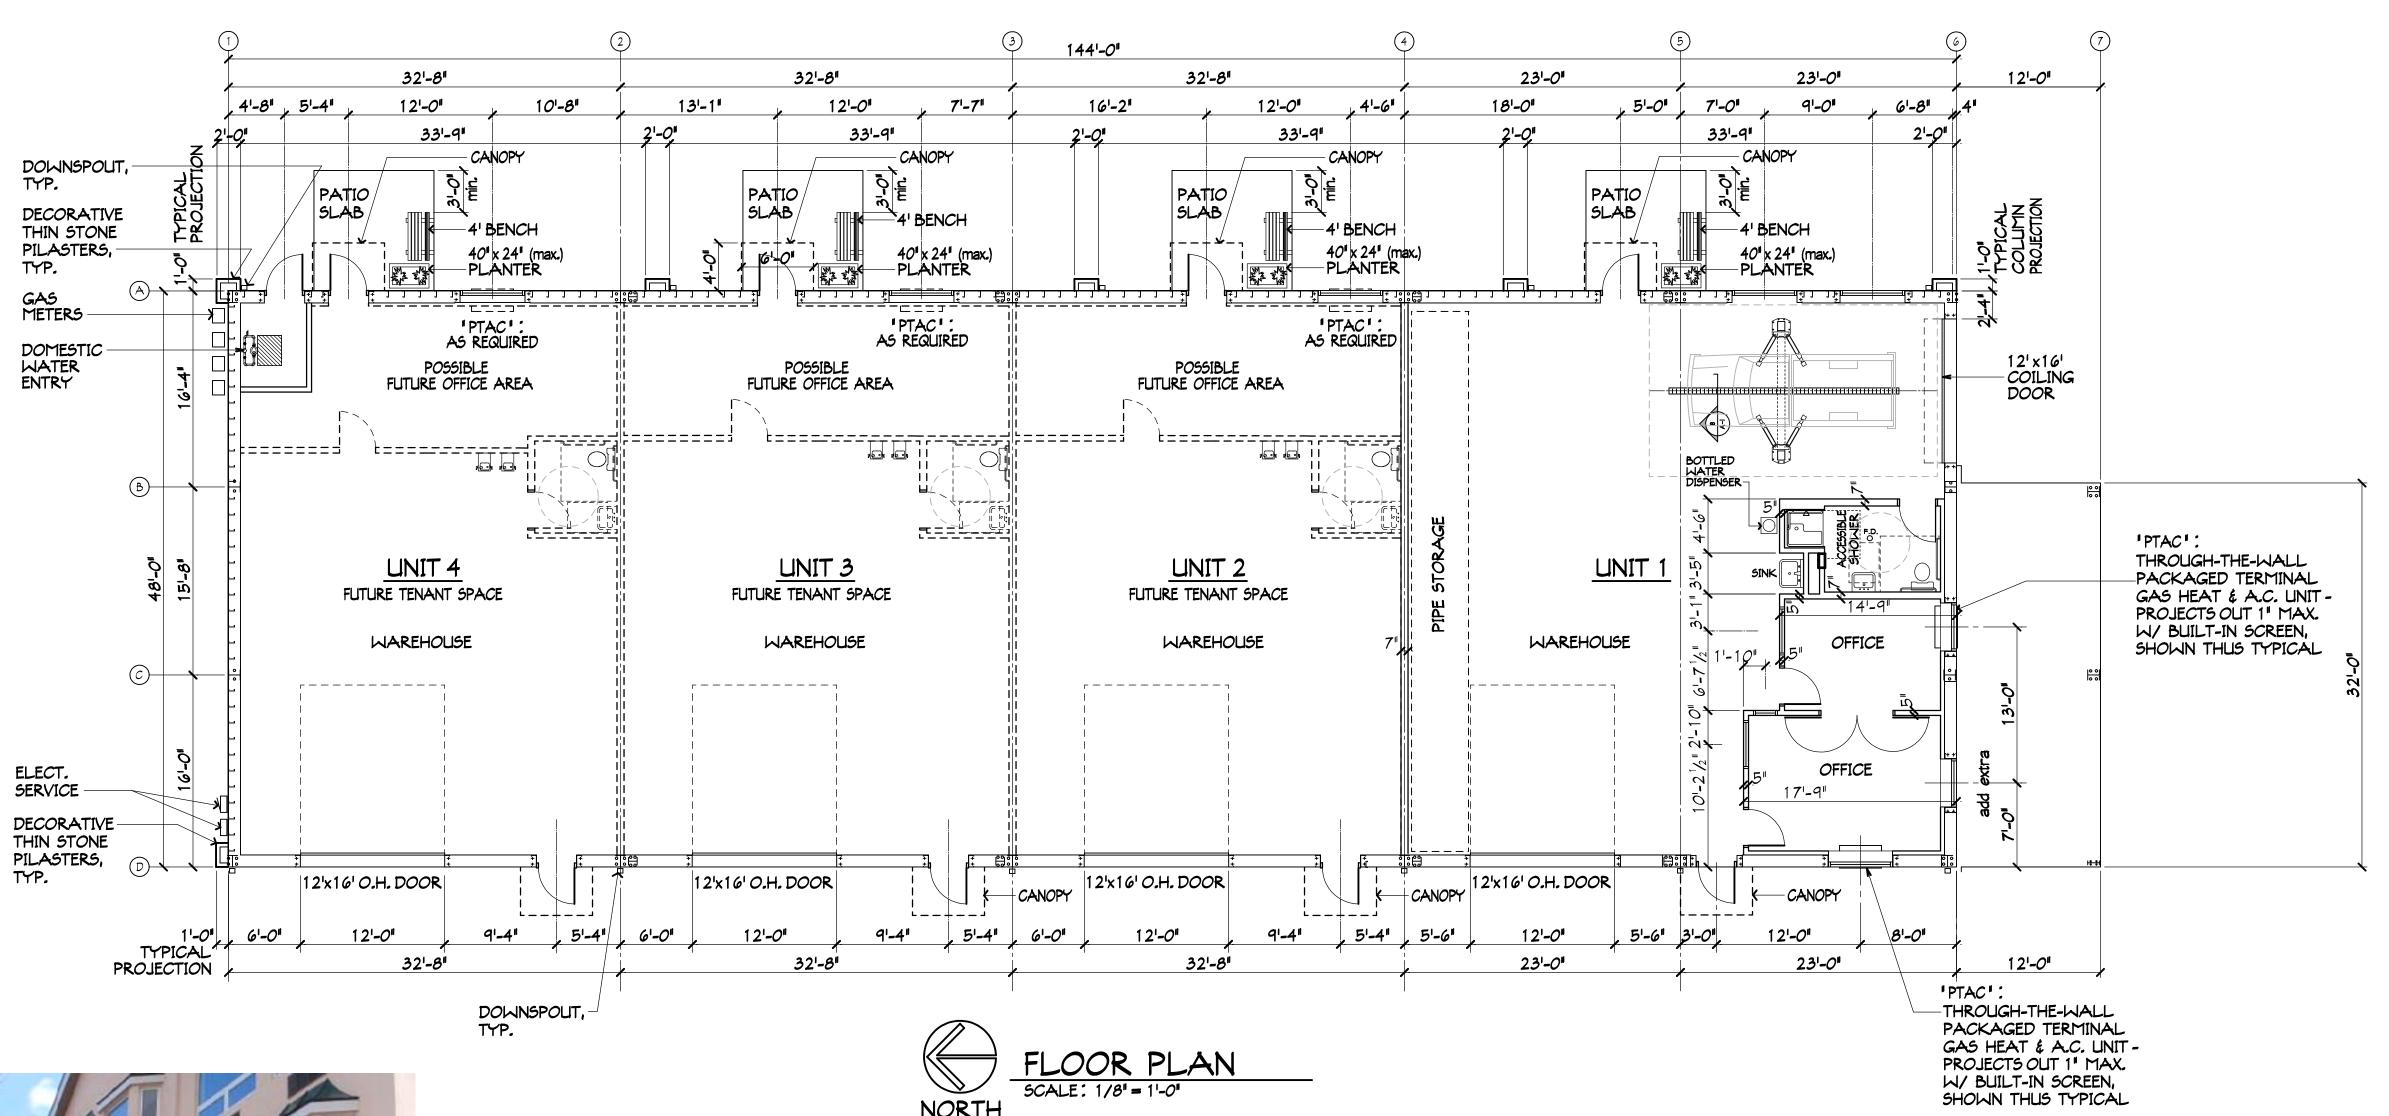



EXAMPLE - PACKAGED TERMINAL GAS HEAT & AC UNIT (can be added as required)

-'PTAC':

CDA **DESIGNED:** DRAWN: CDA CHECKED: 08/23/10 DATE:

40USE SPRIN

FIRESTONE INFORMATION BLOCK				
FLOOR	PLAN SHEET			
Name of Submittal:	Longs Peak Sprinkler			
Type of Submittal:	SPECIAL REVIEW LISE			

PROJECT: 16293 Filing Number: 5/10/2016 Preparation Date: 7/28/16 TOWN REVIEW COMMENTS **Revisions Date:** Revisions Date: 12/9/16 TOWN REVIEW COMMENTS **Revisions Date:**

11 of 13

DRAWING A-1 **SHEET** 11 **OF** 13

REVISIONS:

LOT 8, AUSTIN INDUSTRIAL PARK LONGS PEAK SPRINKLER, 460 JONES COURT LOCATED IN THE SOUTHWEST QUARTER OF SECTION 19, TOWNSHIP 1 NORTH, RANGE 68 WEST OF THE 6TH P.M. TOWN OF ERIE, COUNTY OF WELD, STATE OF COLORADO 0.97± ACRES SITE PLAN - SP - 000775-2016 SRU AREA - 0.97 ± ACRES - TOTAL AREA 0.97 ± ACRES SPECIAL REVIEW USE SITE PLAN - SRU-000774-2016 AREA CUTOFF WALL MOUNTED LIGHT FIXTURE SHOWN THUS, SEE PHOTOMETRIC PLAN 5 144'-0" - PREFINISHED STEEL ROOF PANELS & TRIM, "BURNISHED SLATE" THIN STONE COLUMNS, "PLUM CREEK" DOWNSPOUT, TYP. - MATCH TRIM COLOR 7" WOODGRAIN LAP SIDING, ALUMINUM WINDOWS, "DARK (CLASSIC) BRONZE" -"POWER GRAY" GIRT PREFINISHED STEEL RIBBED MANKO, SERIES 600 XO SHEETING, 'BURNISHED SLATE' , 6'-0" -FUTURE 'PTAC': TYP. CANOPY WIDTH GLASS: 1' IGU, OPTIGRAY + SUNGATE 400 (3) CLEAR LOW-E, THROUGH-THE-WALL CORBELS: WOOD FRAMED ROOF OVERHANG AT ENTRY DOORS VLT = 54%, SHGC = 0.46, LSG = 1.17, WINTER U-VALUE = 0.32, PACKAGED TERMINAL MOOD CASING—AROUND DOORS & WINDOWS PAINTED "HONEY" COLOR 30" x 18" — SIGN AT EACH UNIT ENTRY PPG INDUSTRIES, INC. GAS HEAT & A.C. UNIT -TYPICAL AS REQUIRED, SHOWN THUS EAST ELEVATION SCALE: 1/8" = 1'-0" AREA CUTOFF WALL MOUNTED LIGHT FIXTURE SHOWN THUS, SEE PHOTOMETRIC PLAN PREFINISHED - STEEL ROOF PANELS & TRIM, "BURNISHED SLATE" THIN STONE - COLUMNS, "PLUM CREEK" 7" WOODGRAIN LAP SIDING, "POWER GRAY" ELECT. HOUSE PANEL ELECT. METER CENTER PREFINISHED STEEL RIBBED SHEETING, 'BURNISHED SLATE' GAS METERS THE BUILDING ELEVATIONS SHOWN AND APPROVED HEREON ARE INTENDED TO 49'-0" DEMONSTRATE HOW ALL HVAC AND OTHER MECHANICAL EQUIPMENT SHALL BE SCREENED ACCORDING TO TOWN OF ERIE, UNIFIED DEVELOPMENT CODE NORTH ELEVATION REQUIREMENTS. IT IS THE APPLICANT'S RESPONSIBILITY TO ENSURE THAT THIS APPROVED SCREENING OCCURS IN THE FIELD AS DEMONSTRATED BY THESE PLANS SCALE: 1/8" = 1'-0" REGARDLESS OF CURB REQUIREMENTS, MECHANICAL PLAN CHANGES OR OTHER CIRCUMSTANCES. FAILURE TO PROVIDE APPROVED SCREENING MAY RESULT IN DELAY OF FINAL INSPECTIONS AND/OR ISSUANCE OF A CERTIFICATE OF OCCUPANCY. CDA **DESIGNED:** - 4x4 CEDAR FRAME 1x CEDAR TRIM - AUTO-OPENER CDA DRAWN: TS 8x8 POST— 5'-0" CDACHECKED: POSTS 08/23/10 DATE: **REVISIONS:** —1x6 DOG EARED CEDAR PICKET FENCE w/ 3 RAILS FIRESTONE INFORMATION BLOCK STAIN TO MATCH "POWER GRAY" **ELEVATIONS SHEET** Name of Submittal: Longs Peak Sprinkler STAIN TO MATCH-1 1 1 1 1111 1111 -1x6 CEDAR PLANKS 11 11 1111 "POWER GRAY" SPECIAL REVIEW USE Type of Submittal: 11 11 STAIN TO MATCH "POWER GRAY" **PROJECT:** 16293 Filing Number: 5/10/2016 Preparation Date: DRAWING STORAGE YARD FENCE STORAGE YARD GATE STORAGE YARD GATE 7/28/16 TOWN REVIEW COMMENTS **Revisions Date:** TYPICAL ELEVATION TYPICAL ELEVATION TYPICAL ELEVATION Revisions Date: 12/30/16 TOWN REVIEW COMMENTS SCALE: 1/4" = 1'-0" SCALE: 1/4" = 1'-0" SCALE: 1/4" = 1'-0" **Revisions Date:** 12 of 13 SHEET **SHEET** 12 **OF** 13

LOT 8, AUSTIN INDUSTRIAL PARK LONGS PEAK SPRINKLER, 460 JONES COURT LOCATED IN THE SOUTHWEST QUARTER OF SECTION 19, TOWNSHIP 1 NORTH, RANGE 68 WEST OF THE 6TH P.M. TOWN OF ERIE, COUNTY OF WELD, STATE OF COLORADO 0.97 ± ACRES SITE PLAN - SP - 000775-2016 SRU AREA - 0.97 ± ACRES - TOTAL AREA 0.97 ± ACRES SPECIAL REVIEW USE SITE PLAN - SRU-000774-2016 PREFINISHED STEEL ROOF PANELS & TRIM, "BURNISHED SLATE" PREFINISHED -STEEL SHEETING - COLOR: PREFINISHED -STEEL SHEETING - COLOR: 'BURNISHED SLATE' 'BURNISHED SLATE' AREA CUTOFF WALL MOUNTED LIGHT FIXTURE 144'-0" SHOWN THUS, SEE PHOTOMETRIC PLAN DOWNSPOUT, TYP. - MATCH TRIM COLOR > LEAN-TO RAKE TRIM, EAVE TRIM & STEEL POSTS PAINTED 'BURNISHED SLATE' ACCENT SIDING: GROOVED LIGHT GAGE PREFINISHED STEEL SHEETING (FW-12 PROFILE), PROPOSED COLOR: THROUGH-THE-WALL "WEATHERED GALVALUME" PACKAGED TERMINAL SHOWN THUS GAS HEAT & A.C. UNIT -SHOWN THUS OVERHEAD DOOR CO. (OR EQUAL) -STEEL SHEETING - COLOR: "BURNISHED SLATE" SERIES 591 INSULATED SECTIONAL DOOR W/ IGU WINDOWS -COLOR TO MATCH POWER GRAY LAP SIDING WEST ELEVATION SCALE: 1/8" = 1'-0" AREA CUTOFF WALL MOUNTED LIGHT FIXTURE OFFICE/WAREHOUSE LONGS PEAK SPRINK 460 JONES COURT ERIE, COLORADO LEAN - TO: PREFINISHED STEEL SHEETING - COLOR: "BURNISHED SLATE" SHOWN THUS, SEE PHOTOMETRIC PLAN AREA CUTOFF WALL PACK LIGHT FIXTURE SHOWN THUS SECONDARY SIDING: PREFINISHED STEEL STEEL GUTTER RIBBED SHEETING, PROPOSED COLOR: BURNISHED SLATE ON STEEL EAVE PURLIN - ALL PAINTED "BURNISHED INSULATED FLAT SLAT COILING DOOR - COLOR TO MATCH POWER GRAY LAP SIDING SLATE" T.O. FOUNDATION-100'-6", TYP. THIN STONE COLUMNS, "PLUM CREEK" COLOR T.O. FLOOR SLAB-100'-0", TYP. 'PTAC' STEEL COLUMNS PAINTED THIS WINDOW IS "BURNISHED SLATE" DROP BOLT FOR SWING GATE COVER SLAB 48 HRS (MIN.) -APPLY HARDENING COMPOUND TO BE AN DRILL HOLES IN PAVEMENT AT CLOSED & OPEN GATE POSITIONS 49'-0" "ADD EXTRA" GATE, L3"x2 1/2"x1/4" FRAME W/ 22 GA. B DECK PANELS PRIMED FOR FIELD PAINTING SOUTH ELEVATION PATCH PAVE AROUND -GATE AS SHOWN SCALE: 1/8" = 1'-0" 3 HEAVY DUTY HINGES EA. DOOR, -WELD TO POST & TO GATE FRAME TS8"x8"x1/4" GATE POSTS, EMBED 4'-0 DEEP IN 24" Ø CONC. FILL W/ CONC. CDA **DESIGNED:** PRECAST CAP ~2 #4 VERTS IN END BLOCK, TYP. CDA 6" CONC. SLAB-ON-GRADE W/ #4 BARS ® 12" E.W. DRAWN: STONE CDA CHECKED: THIN STONE ON THREE SIDES COLOR & TYPE PAINTED STEEL GATES 08/23/16 DATE: TO MATCH BUILDING ON STEEL POSTS -**REVISIONS:** COLUMNS -THIN STONE "PLUM CREEK" ON END OF WALL FIRESTONE INFORMATION BLOCK 8" STANDARD CMU WALL W/ PRECAST COPING OVER TOP COURSE APPLY THIN STONE VENEER TO THREE EXTERIOR SIDES AND TO WALL ENDS ® WAINSCOTAPPLY HARDI-BOARD LAP SIDING TO THREE EXTERIOR SIDES AND TO WALL ENDS ABOVE WAINSCOT. HARDI-BOARD LAP **ELEVATIONS SHEET** SIDING TO MATCH BUILDING Longs Peak Sprinkler Name of Submittal: SPECIAL REVIEW USE Type of Submittal: "POWER GRAY" 16293 PROJECT: 12'-8" Filing Number: Preparation Date: 5/10/2016 DRAWING TRASH ENCLOSURE TRASH ENCLOSURE 7/28/16 TOWN REVIEW COMMENTS Revisions Date: SOUTH ELEVATION EAST ELEVATION PLAN - TRASH ENCLOSURE Revisions Date: 12/30/16 TOWN REVIEW COMMENTS Revisions Date: SCALE: 1/4"=1'-0" SCALE: 1/4" = 1'-0" SCALE: 1/4" = 1'-0" 13 13 of SHEET 3 OF