

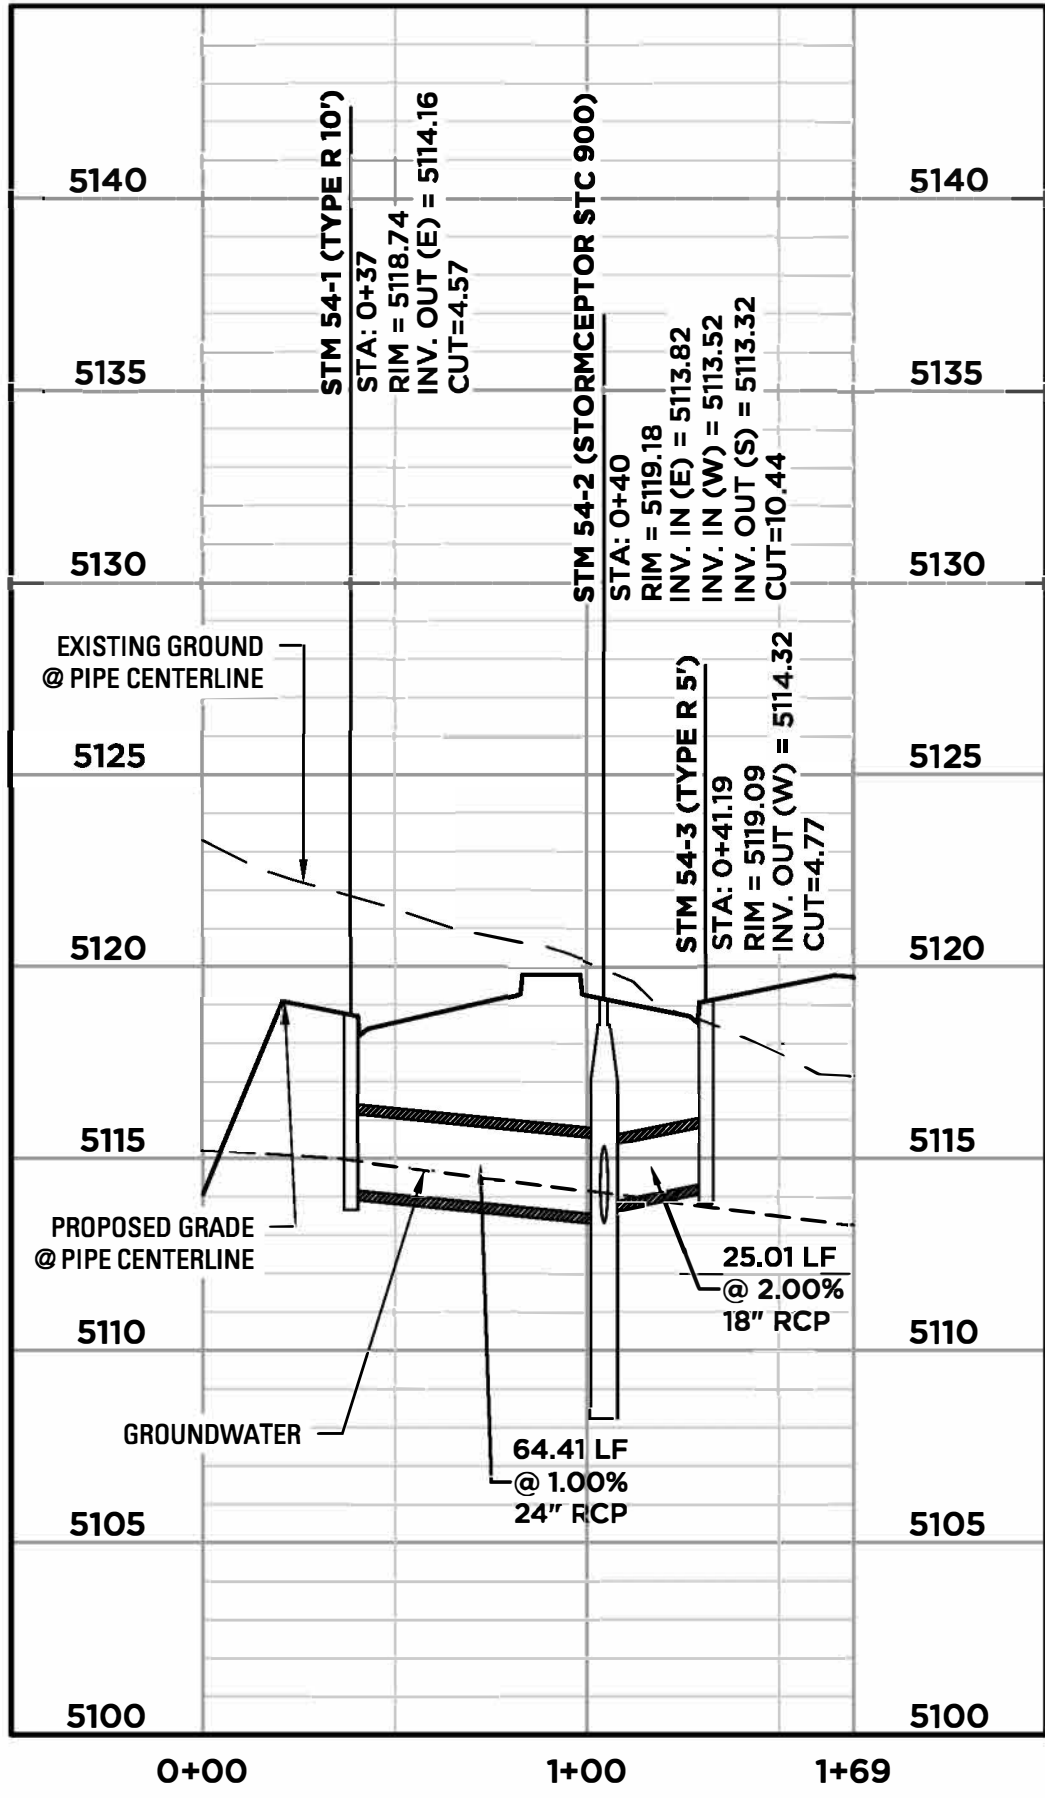




STORM 54 PROFILE

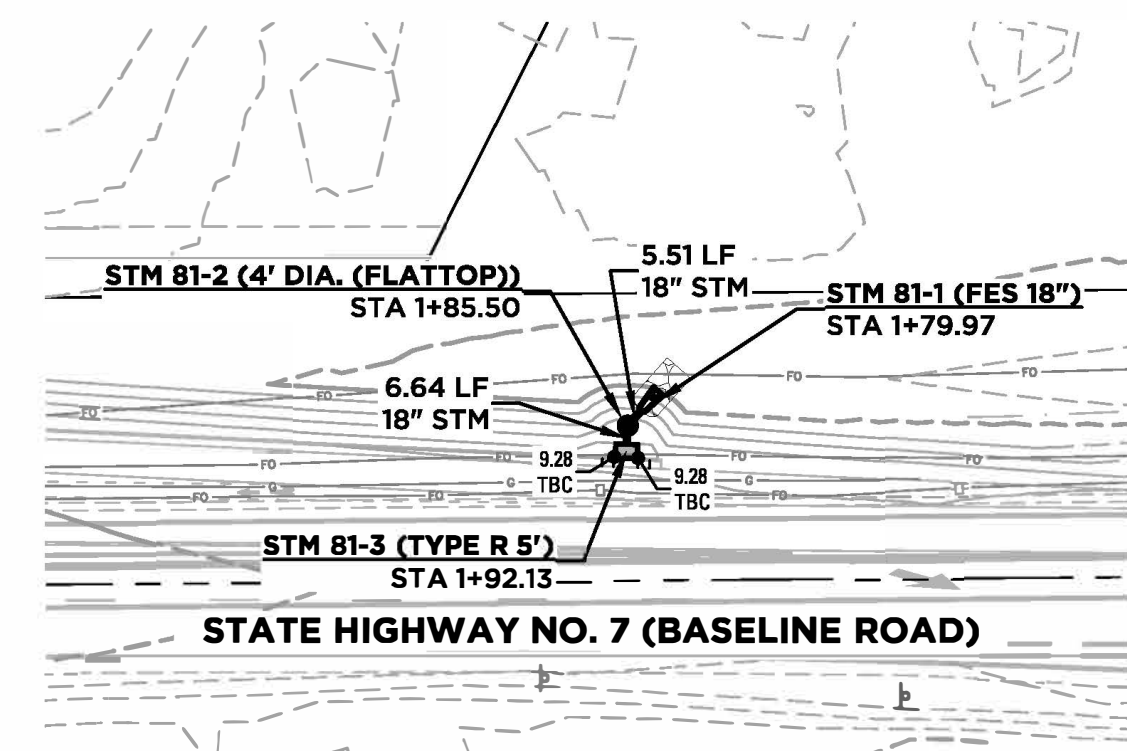

STORM 55 PROFILE

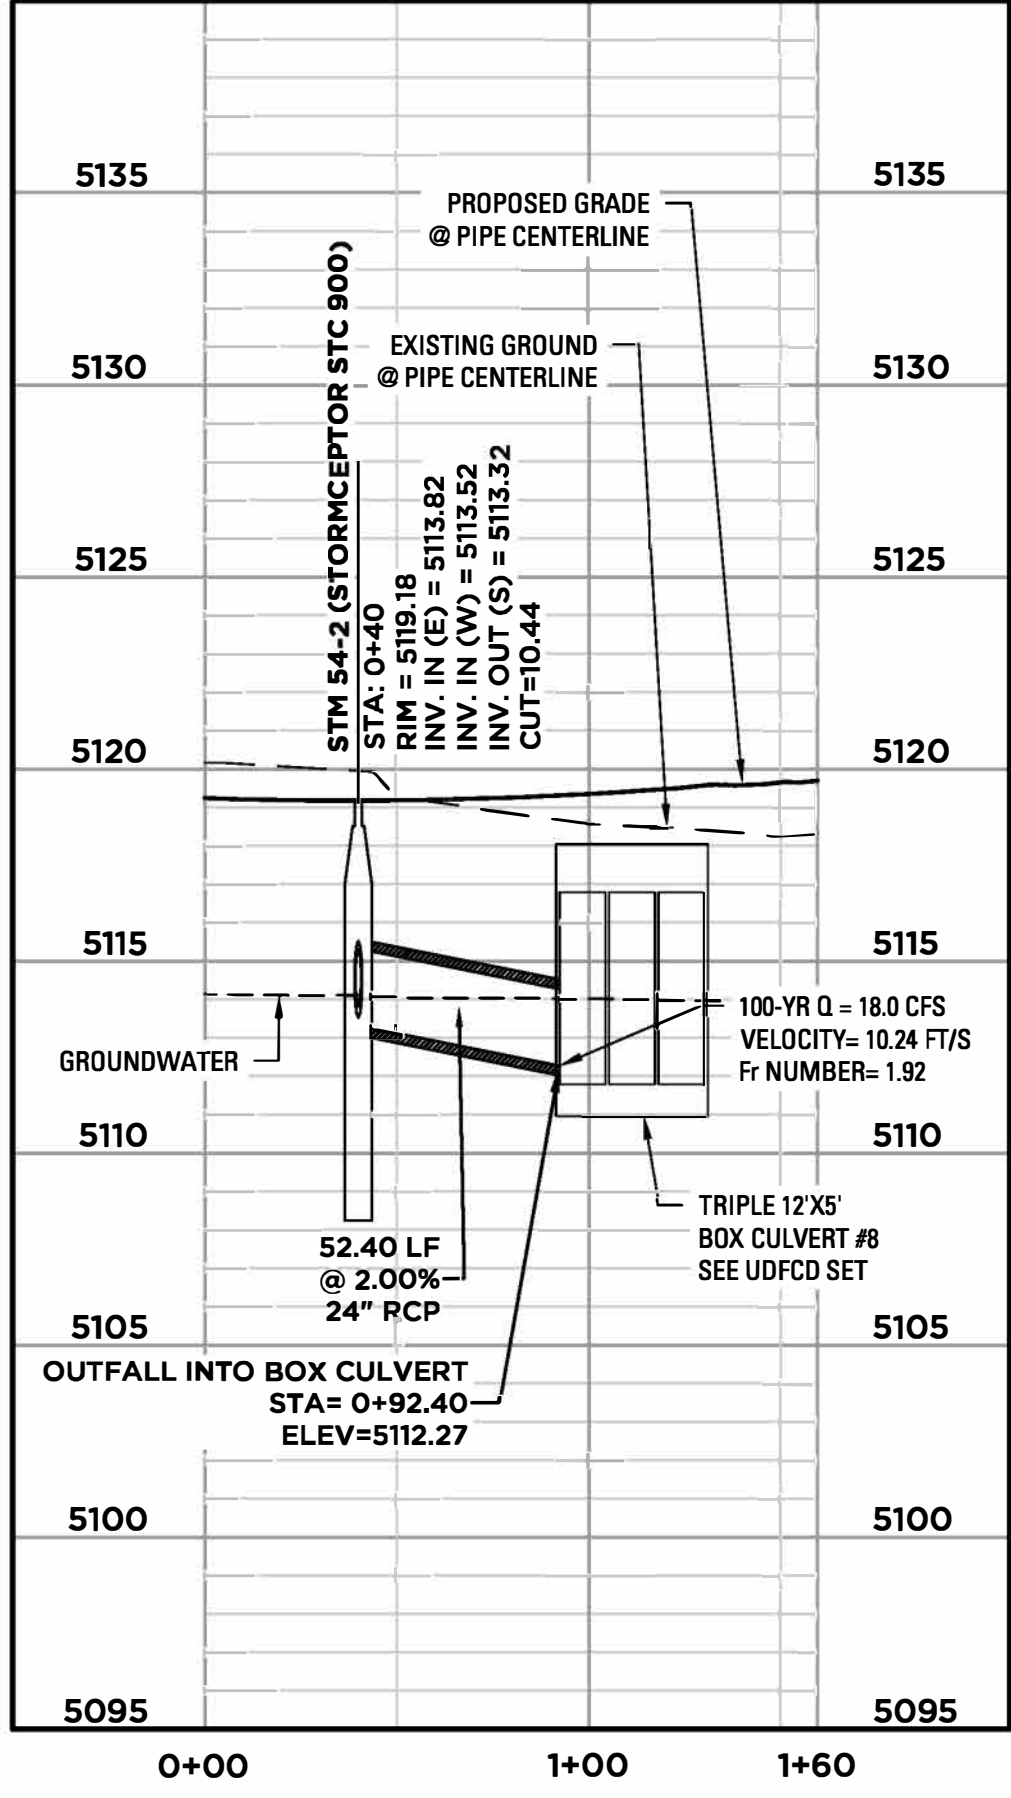

STORM 81 PLAN & PROFILE

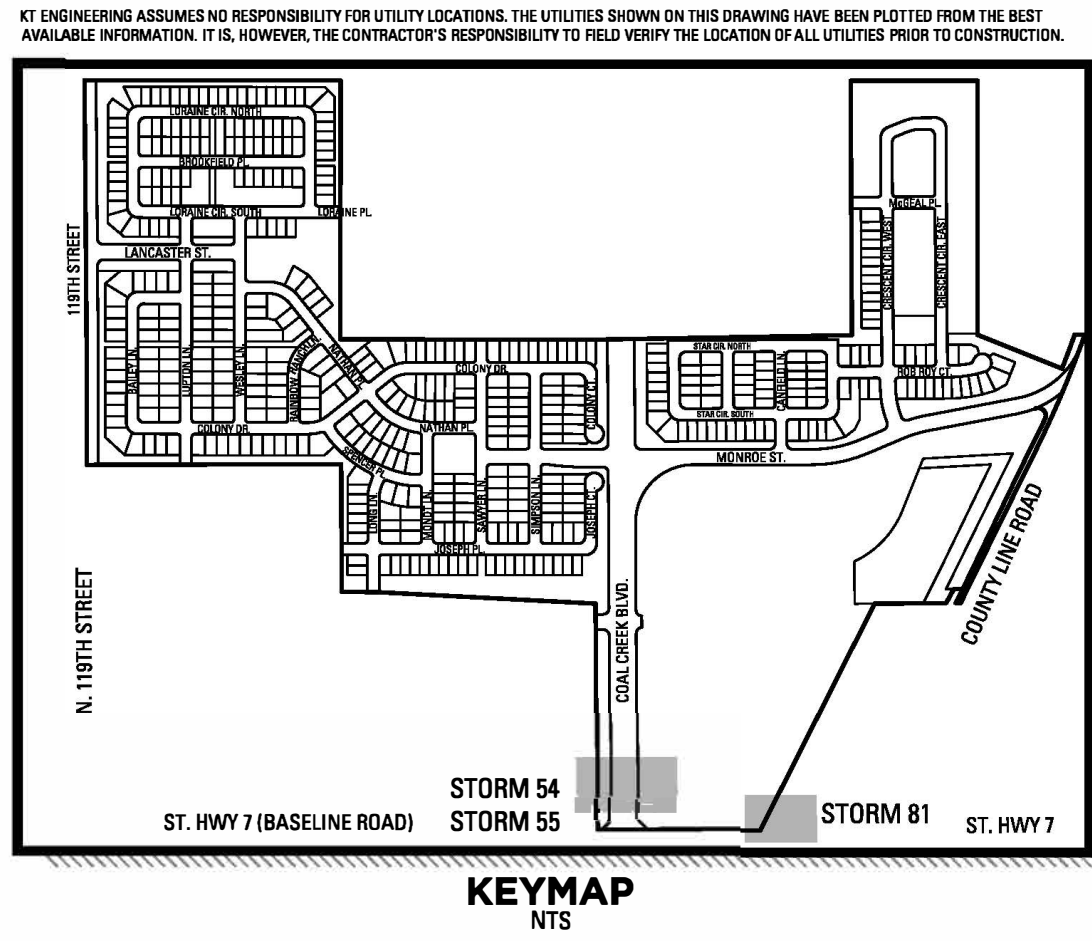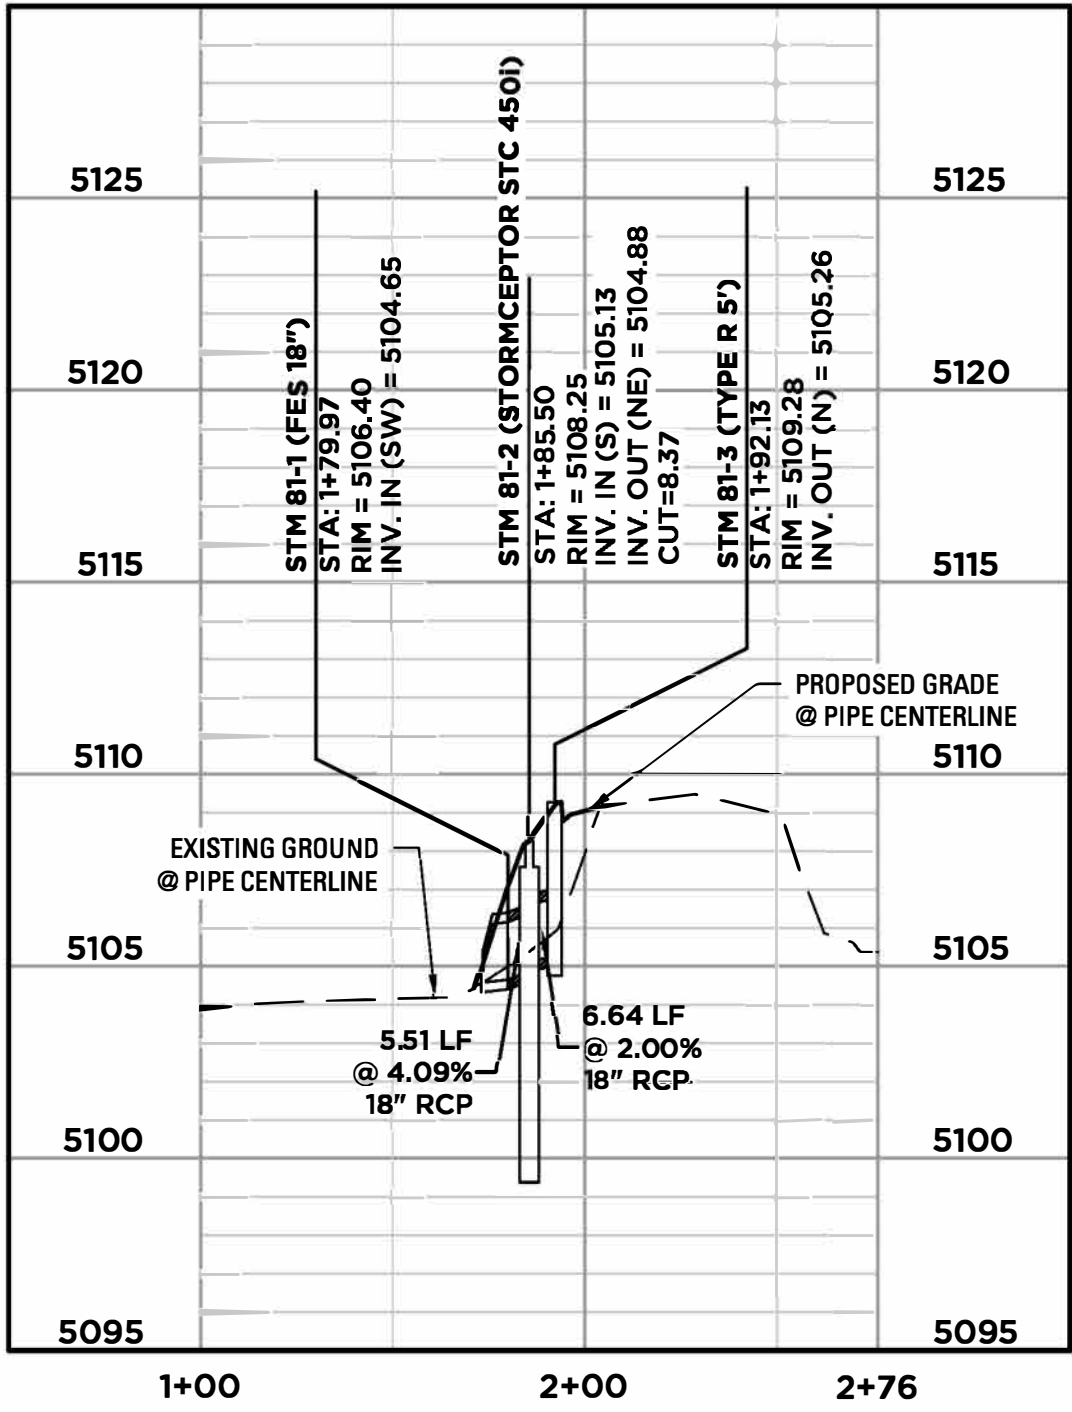

PARKDALE SUBDIVISION
STORMCEPTOR
OPERATIONS AND
MAINTENANCE PLAN

THE TOWN OF ERIE IS RESPONSIBLE
FOR INSPECTION AND MAINTENANCE

CDOT REGION 4, BOULDER COUNTY



KT ENGINEERING

12500 W. 58TH AVE. #230
ARVADA, CO 80002
P: 720.638.5190

WWW.KTENG.NET

PREPARED FOR:
OEO, LLC

REVISIONS:

NO.	BY	DATE	REVISION DESCRIPTION
1			
2			
3			
4			
5			
6			

STAMP:

SHEET INFO:

PARKDALE
STORM 54, 55 & 81 PLAN AND PROFILE
STORMCEPTOR OPERATION AND
MAINTENANCE PLAN

PROJECT NO:
0043-1532

DRAWN BY:
KBS



DESIGNED BY:
BSS

SCALE:
1" = 50'


SUBMITTED ON:
02/01/2021

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OF 01


STORM 54 & 55 PLAN

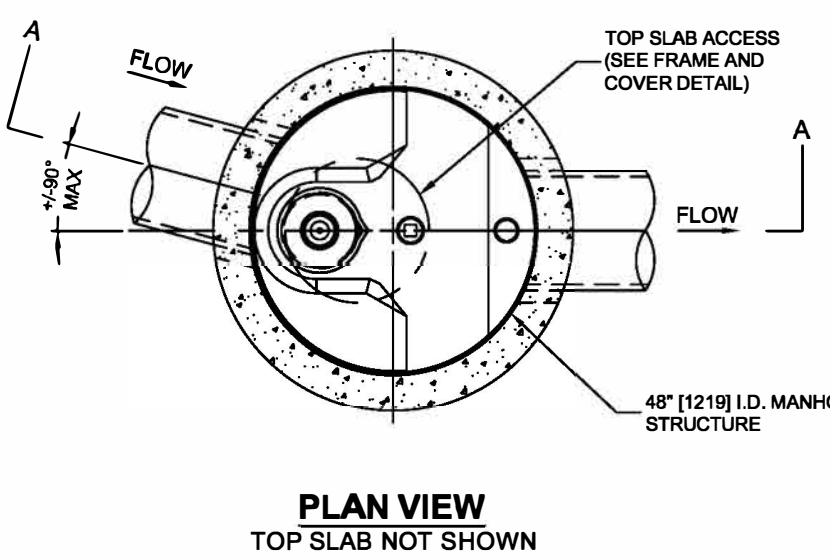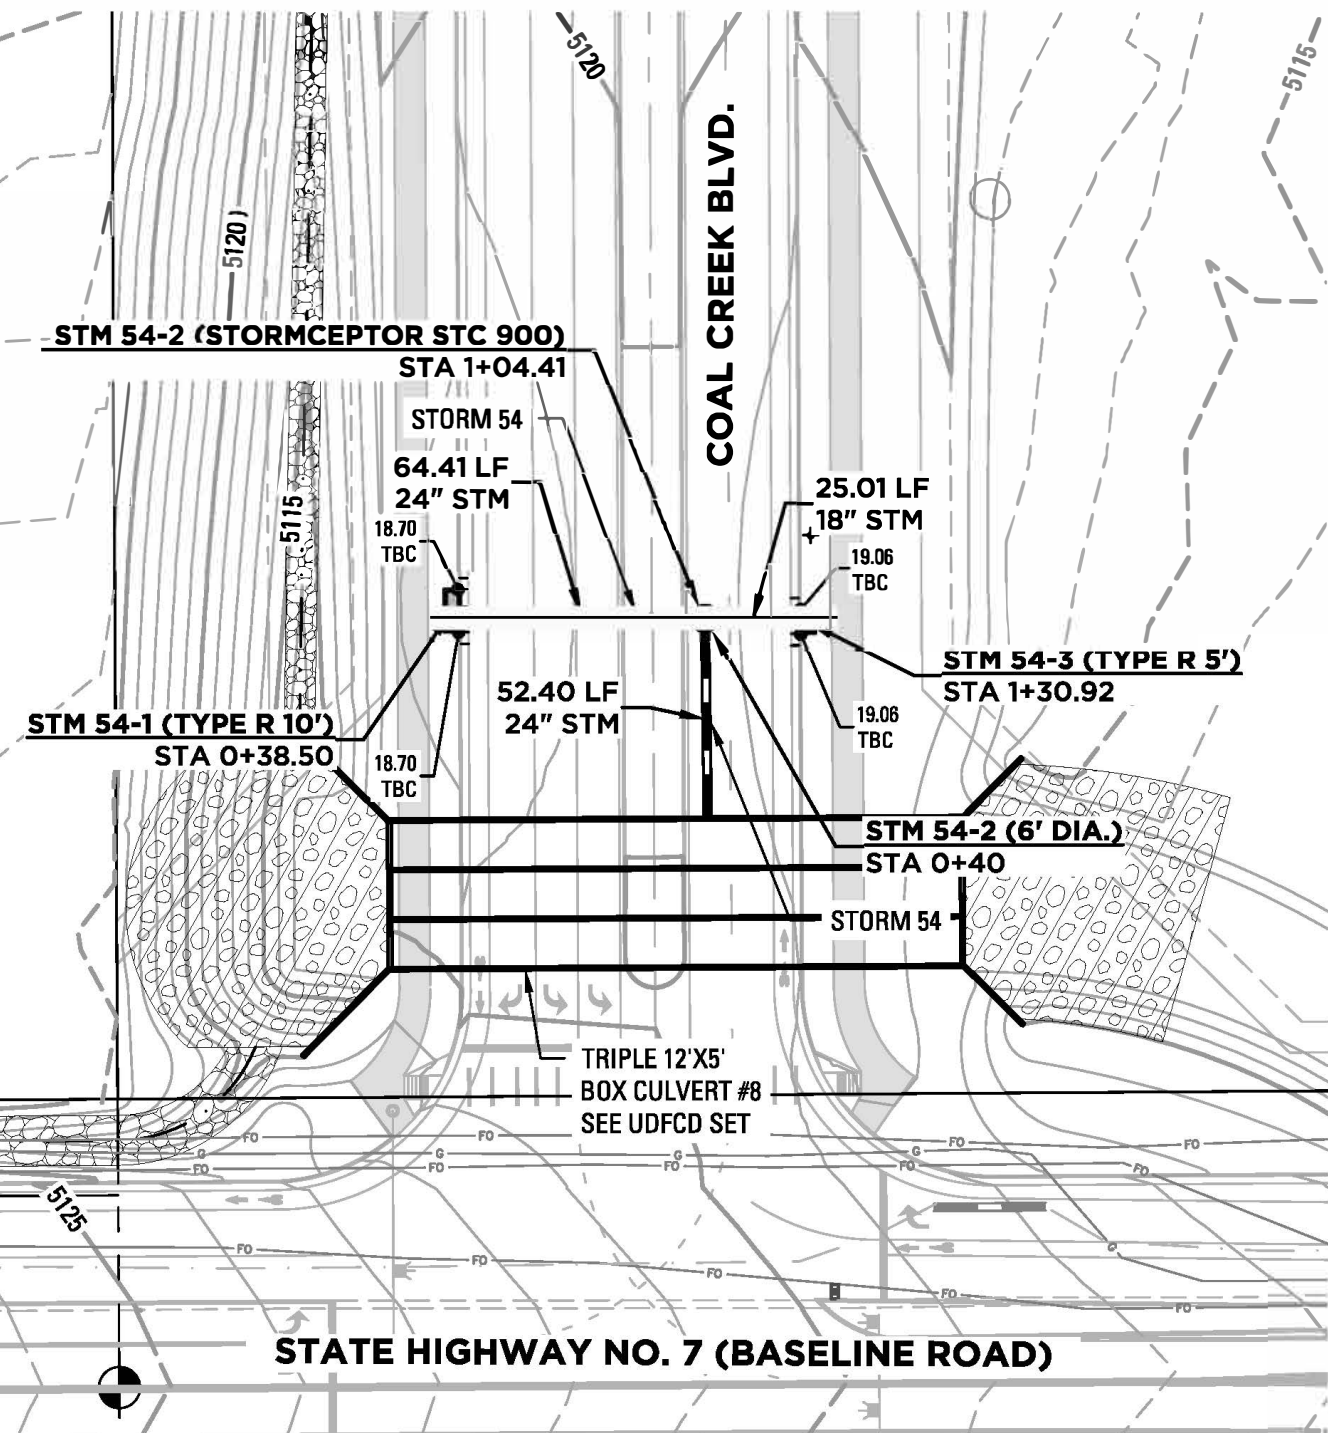


PLAN VIEW
TOP SLAB NOT SHOWN

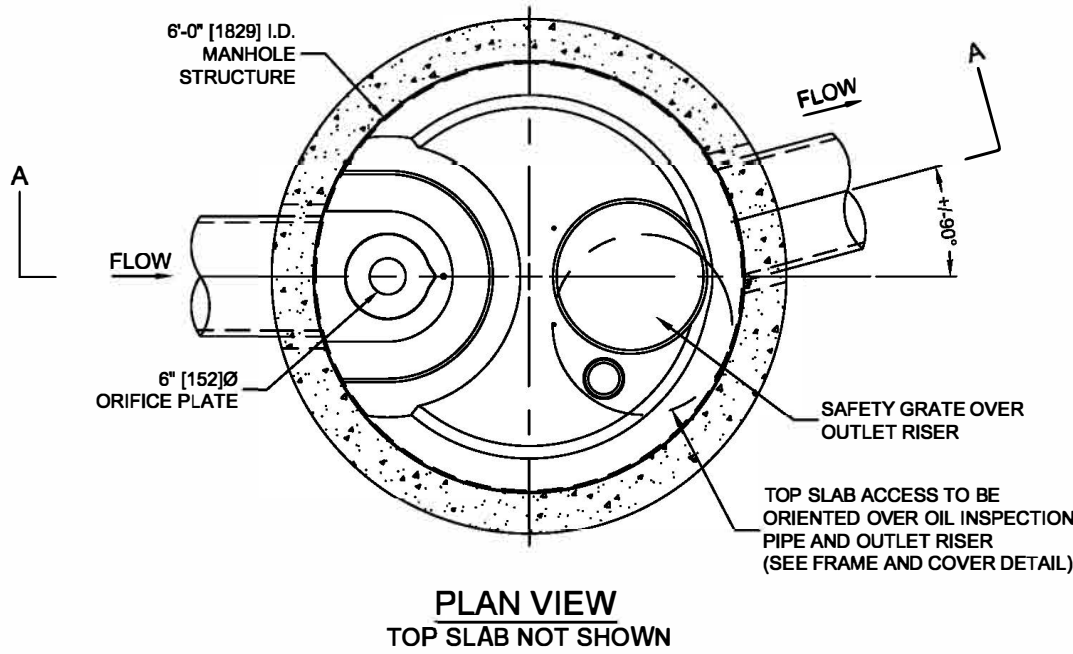

PLAN VIEW
TOP SLAB NOT SHOWN

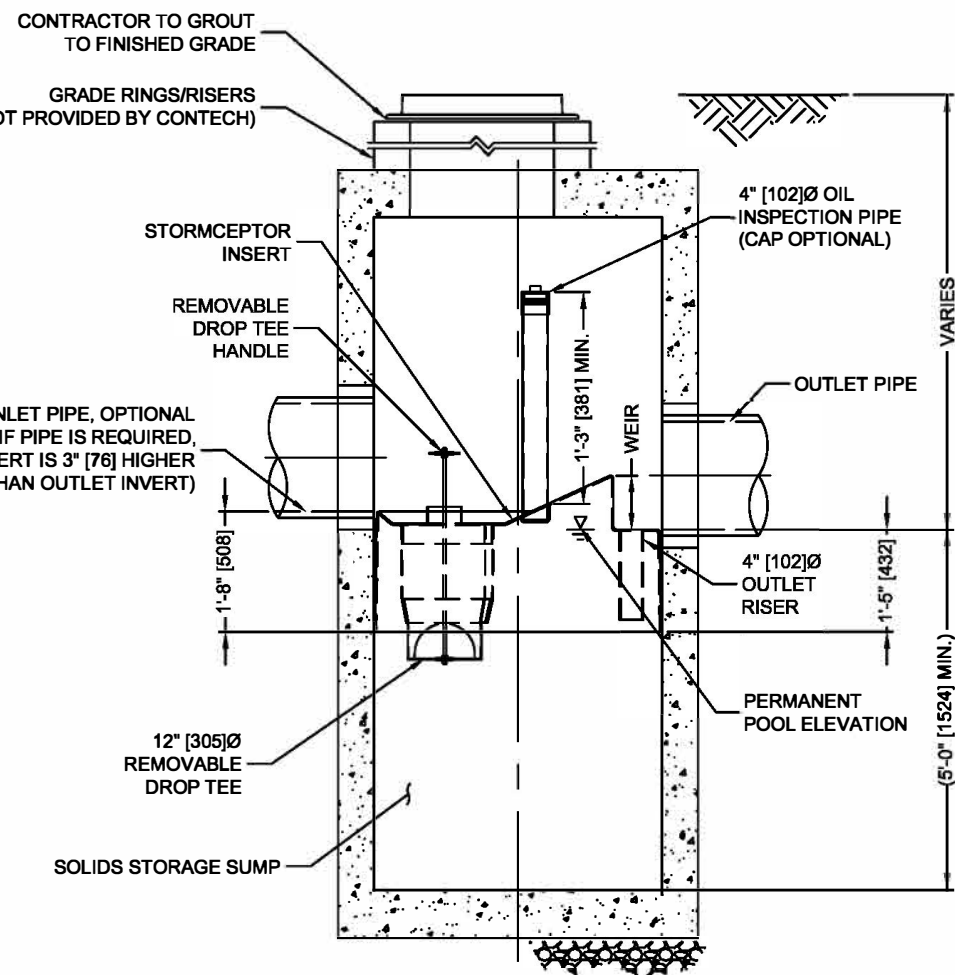

SECTION A-A
STC 450i
STORMCEPTOR
STANDARD DETAIL

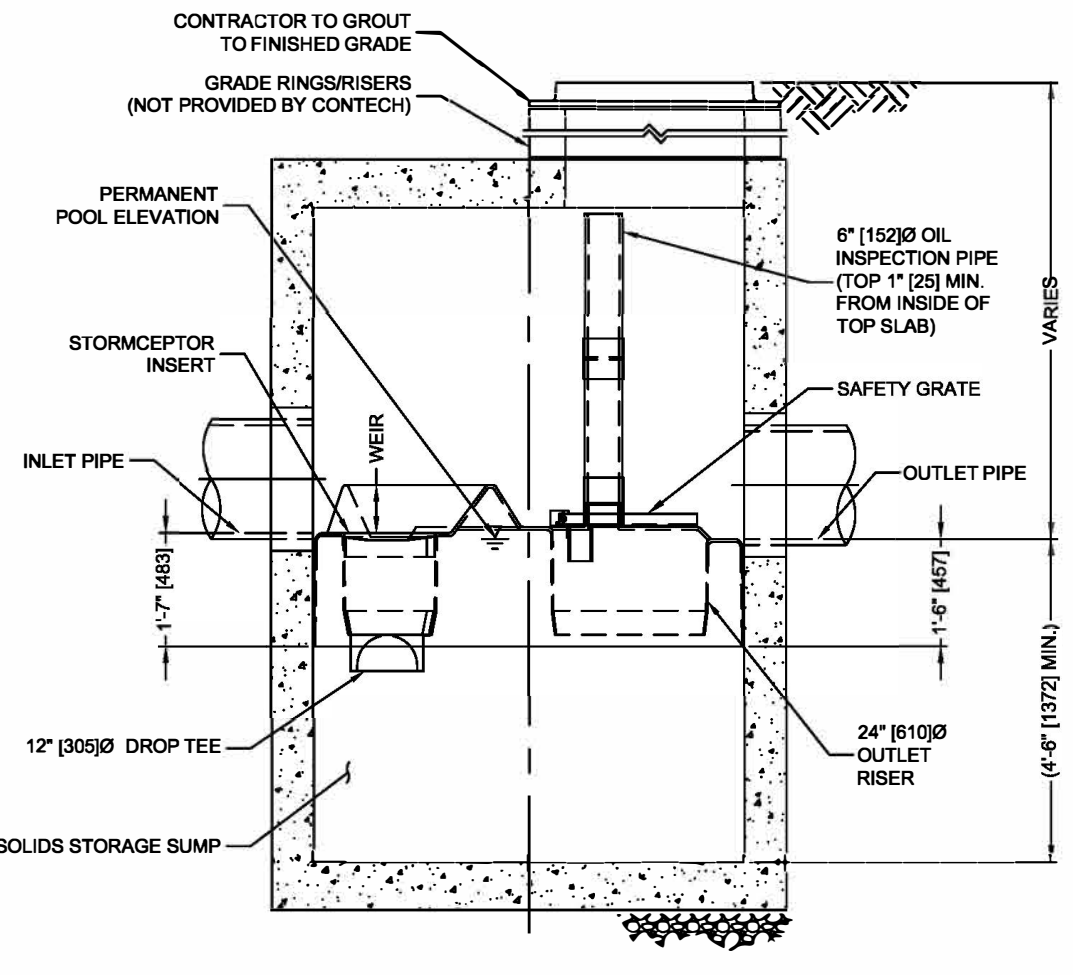

SECTION A-A
STC 900
STORMCEPTOR
STANDARD DETAIL

- GENERAL NOTES**
- CONTECH TO PROVIDE ALL MATERIALS UNLESS NOTED OTHERWISE.
 - FOR SITE SPECIFIC DRAWINGS WITH DETAILED STRUCTURE DIMENSIONS AND WEIGHT, PLEASE CONTACT YOUR CONTECH ENGINEERED SOLUTIONS LLC REPRESENTATIVE. www.ContechES.com
 - STORMCEPTOR WATER QUALITY STRUCTURE SHALL BE IN ACCORDANCE WITH ALL DESIGN DATA AND INFORMATION CONTAINED IN THIS DRAWING. CONTRACTOR TO CONFIRM STRUCTURE MEETS REQUIREMENTS OF PROJECT.
 - STORMCEPTOR STRUCTURE SHALL MEET AASHTO HS20 LOAD RATING, ASSUMING EARTH COVER OF 0' - 2' [810], AND GROUNDWATER ELEVATION AT, OR BELOW, THE OUTLET PIPE INVERT ELEVATION. ENGINEER OF RECORD TO CONFIRM ACTUAL GROUNDWATER ELEVATION. CASTINGS SHALL MEET AASHTO M308 AND BE CAST WITH THE CONTECH LOGO.
 - STORMCEPTOR STRUCTURE SHALL BE PRECAST CONCRETE CONFORMING TO ASTM C478 AND AASHTO LOAD FACTOR DESIGN METHOD.
 - ALTERNATE UNITS ARE SHOWN IN MILLIMETERS [mm].
- INSTALLATION NOTES**
- ANY SUB-BASE, BACKFILL DEPTH, AND/OR ANTI-FLOTATION PROVISIONS ARE SITE-SPECIFIC DESIGN CONSIDERATIONS AND SHALL BE SPECIFIED BY ENGINEER OF RECORD.
 - CONTRACTOR TO PROVIDE EQUIPMENT WITH SUFFICIENT LIFTING AND REACH CAPACITY TO LIFT AND SET THE STORMCEPTOR MANHOLE STRUCTURE.
 - CONTRACTOR TO INSTALL JOINT SEALANT BETWEEN ALL STRUCTURE SECTIONS AND ASSEMBLE STRUCTURE.
 - CONTRACTOR TO PROVIDE, INSTALL, AND GROUT INLET AND OUTLET PIPE(S). MATCH PIPE INVERTS WITH ELEVATIONS SHOWN. ALL PIPE CENTERLINES TO MATCH PIPE OPENING CENTERLINES.
 - CONTRACTOR TO TAKE APPROPRIATE MEASURES TO ASSURE UNIT IS WATER TIGHT, HOLDING WATER TO FLOWLINE INVERT MINIMUM. IT IS SUGGESTED THAT ALL JOINTS BELOW PIPE INVERTS ARE GROUTED.



STORMCEPTOR INSTALLATION
STANDARD DETAILS



8029 Centre Pointe Dr., Suite 400, West Chester, OH 45069
800-338-1122 513-645-7000 513-645-7993 FAX